

Marigold Stage 8

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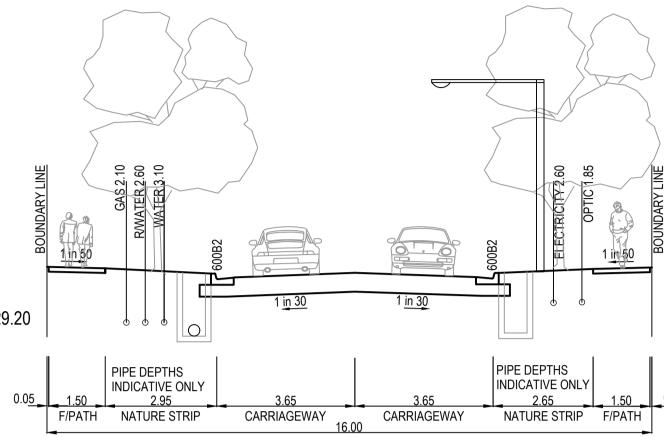
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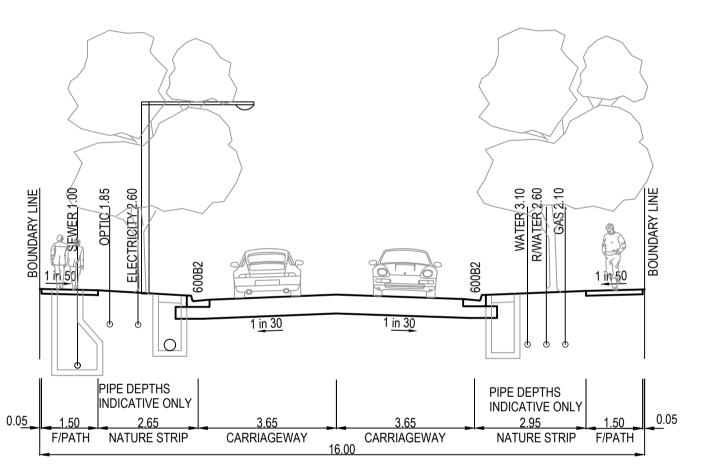
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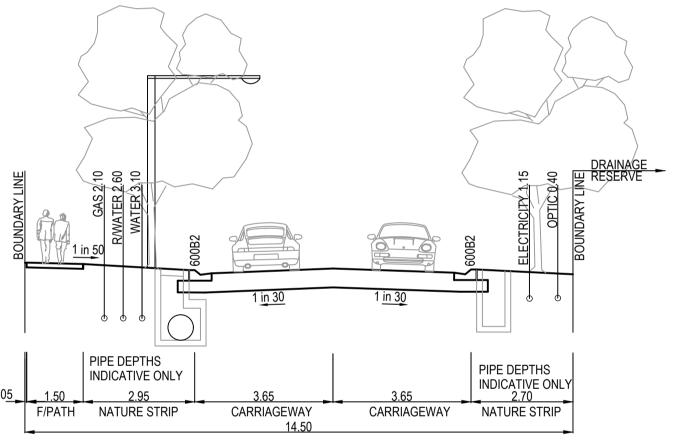
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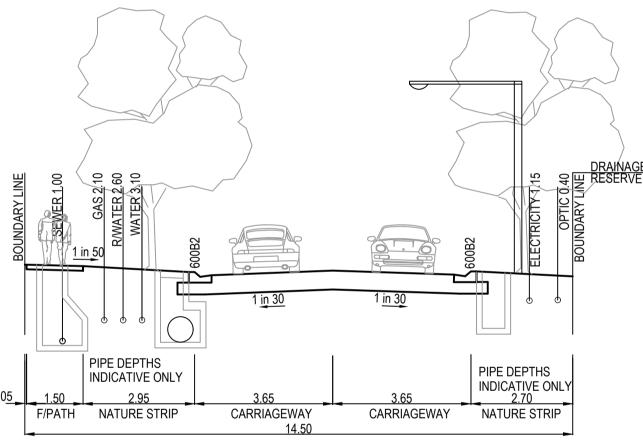
16m ROAD RESERVE PRAISE ROAD




16m ROAD RESERVE KINDNESS ROAD




14.5m ROAD RESERVE RECOGNITION AVENUE




14.5m ROAD RESERVE RECOGNITION AVENUE (LOTS 801-806)

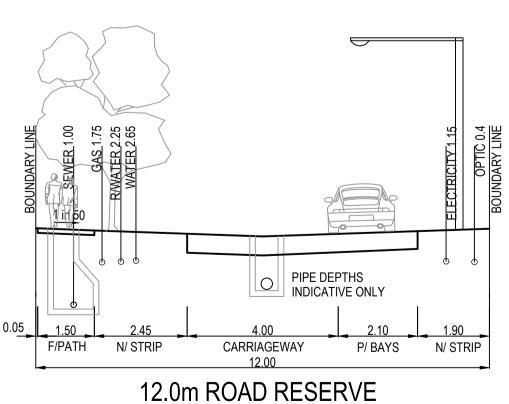

CROWD ROAD (LOTS 810-812) **EXTENDED DRIVEWAY**

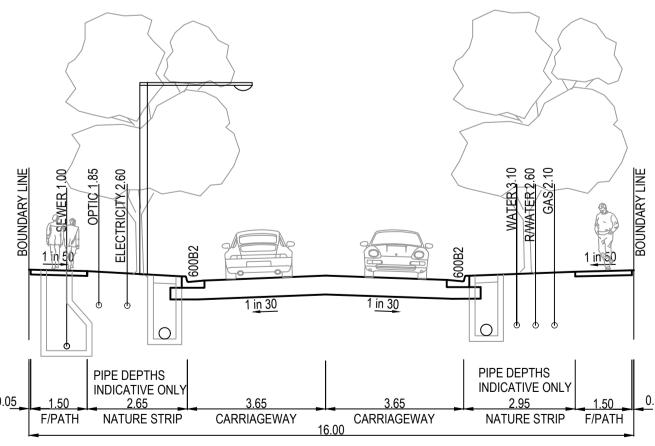

16m ROAD RESERVE CROWD ROAD (LOTS 806-809)

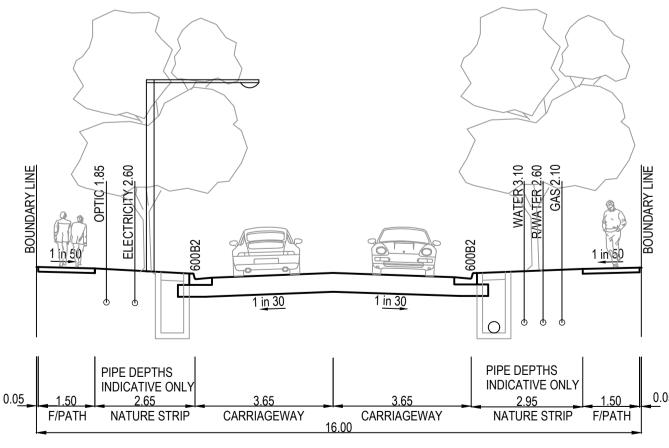

16m ROAD RESERVE

WARNING

ASSESS THE RISK - STAY SAFI

GENERAL NOTES (WYNDHAM CITY COUNCIL)

THE WORKS SHALL BE CONSTRUCTED IN ACCORDANCE WITH THE CURRENT EDCM ADDENDUM STANDARD

2. THE CONTRACTOR IS RESPONSIBLE FOR SAFETY OF WORK ON SITE IN ACCORDANCE WITH APPROPRIATE LEGISLATION. THE CONTRACTOR SHALL ERECT AND MAINTAIN ALL SHORING, PLANKING AND STRUTTING, DEWATERING DEVICES, BARRICADES, SIGNS, LIGHTS, ETC. NECESSARY TO KEEP WORKS IN A SAFE AND STABLE

CONDITION, AND TO PROTECT THE PUBLIC FROM HAZARDS ASSOCIATED WITH THE WORKS.

4. THE CONTRACTOR IS TO NOTIFY COUNCIL AND ALL SERVICE AUTHORITIES SEVEN (7) DAYS PRIOR TO

DRAWINGS ARE OFFERED AS A GUIDE ONLY AND ARE NOT GUARANTEED AS CORRECT

NOT SCALE OFF THESE DRAWINGS, WRITTEN DIMENSIONS ONLY SHALL BE USED

RULES, AND THE MINES (TRENCHES) REGULATIONS 1982.

WHEN TRENCHING OPERATIONS ARE IN PROGRESS.

APPROVAL HAS BEEN GIVEN BY COUNCIL'S SUPERVISING OFFICER.

COMMENCEMENT OF CONSTRUCTION.

EDCM 202 (EXPANSIVE SUBGRADE).

CONSENT OF THE ENGINEER.

(VICROADS SPECIFICATION SEE SECTION 710&722).

11. ALL LEVELS ARE TO AUSTRALIAN HEIGHT DATUM.

CONTRACTOR AND FORWARDED TO COUNCIL

150 TO THE DRAINAGE OUTLET SHOWN

WITH CLASS 2 F.C.R.

SPECIFICATION.

FRONT OF PATH/BUILDING LINE.

25. FOOTPATH CROSSFALL TO BE 1:50

BE COMPLETED AND PROVIDED TO SUPERINTENDENT.

AS PER WYNDHAM CITY COUNCIL STANDARD DRAWING SD6-10.

SPECIFICATIONS AND MPA STANDARD DRAWINGS EDCM 401 TO 403.

BE REINSTATED TO THE SATISFACTION OF THE COUNCIL ENGINEER.

GAS MAINS, FITTINGS AND MARKER TAPE ARE TO BE SUPPLIED BY THE GAS AUTHORITY

EXCAVATION, SUPPLY AND PLACEMENT OF REQUIRED BACKFILL TO BE UNDERTAKEN BY OTHERS. NOTIFICATION MUST BE GIVEN TO THE GAS AUTHORITY TWO WEEKS PRIOR TO THE COMMENCEMENT OF

33. TOTAL LENGTH OF ROADS CONSTRUCTED IS ROADLENGTH TOTAL LENGTH OF DRAINS CONSTRUCTED IS DRAINLENGTH ALL TGSI TO BE INSTALLED IN ACCORDANCE WITH AS1428

MARKER POST TO INDICATE LOCATION OF FIREPLUG.

DRAWINGS OF WYNDHAM CITY COUNCIL.

GAS - STANDARD NOTES

REINFORCED CONCRETE PIPE

LOCATED WITHIN THE WORKS ARE TO BE REMOVED AND DISPOSED OFFSITE

15. FILL & CUT BATTERS ARE NOT TO EXCEED 1 in 6 SLOPE, UNLESS SHOWN OTHERWISE.

OPERATIONS WHERE TRENCHES ARE 1.5 METRES OR DEEPER.

DRAWINGS AND SPECIFICATIONS. WORKS TO BE CARRIED OUT TO THE SATISFACTION OF COUNCIL'S SUPERVISING

COMPLY WITH THE SAFETY REQUIREMENTS OF THE MINES ACT, GENERAL REGULATIONS AND STATUTORY

NOTIFY THE OCCUPATIONAL HEALTH AND SAFETY AUTHORITY OF THEIR INTENTION TO COMMENCE TRENCHING

ENSURE THAT THE MINE MANAGER OR THEIR DEPUTY AS REQUIRED BY THE REGULATIONS IS IN ATTENDANCE

THE LOCATION OF EXISTING SERVICES SHOULD BE DETERMINED BY THE CONTRACTOR PRIOR TO COMMENCING ANY EXCAVATION BY CONTACTING ALL RELEVENT SERVICE AUTHORITIES. ANY EXISTING SERVICES SHOWN ON THE

TREES MARKED ON THE APPROVED PLANS FOR REMOVAL MUST BE REMOVED FROM THE SITE PRIOR TO THE COMMENCEMENT OF WORKS. NO EXCAVATION SHALL BE CARRIED OUT WITHIN 5.0m OF ANY EXISTING TREE UNTIL

ALL ROAD CHAINAGES ARE MEASURED ALONG THE ROAD CENTRELINE EXCEPT KERB RETURNS AND COURTHEADS

WHERE LIP OF KERB CHAINAGES ARE SPECIFIED. ALL DIMENSIONS AND RADII ARE GIVEN TO THE LIP OF KERB. DO

CONDUIT LOCATIONS ARE SUBJECT TO AMENDMENT AND CONDUITS SHALL NOT BE LAID UNTIL WRITTEN APPROVAL

IS GIVEN BY THE SUPERINTENDENT. BOTH KERBS ARE TO BE MARKED WITH THE LETTERS E,G,H,R,T&W ABOVE CONDUIT LOCATIONS AS SPECIFIED. RESPECTIVE LETTERS TO BE INDICATED ABOVE RELEVANT CONDUITS AS PEF

STANDARD DRAWING EDCM 303. CONDUITS TO BE PLACED MINIMUM OF 5m FROM BOUNDARIES WHERE POSSIBLE

SUBSOIL DRAINS SHALL BE INSTALLED BEHIND OR BELOW ALL KERB AND CHANNEL AS PER STANDARD DRAWINGS

AND TO THE SATISFACTION OF THE SUPERINTENDENT IN ACCORDANCE WITH COUNCIL STANDARD DRAWINGS.

REQUIREMENTS WITH LATERAL WORKS AND ARROWSBEING COLD APPLIED PLASTIC TROWELLED INTO PLACE (MATERIAL DEGAOUR OR PLASTELINE) AND LONGITUDINAL LINES BEING EXTRUDED THERMOPLASTIC MATERIAL

12. THE CONTRACTOR WHEN ENGAGED IN BLASTING OPERATION, SHALL NOT BLAST WITHIN 4.5m OF AN EXISTING LINE

200mm MAXIMUM LAYER OF TOPSOIL AS SPECIFIED. ALL FILLING ON ALLOTMENTS TO BE COMPACTED TO 95%

ALL EXCAVATED OR FILLED AREAS OUTSIDE THE ROAD RESERVES SHALL BE SURFACED WITH A 100mm MINIMUM TO

STANDARD COMPACTION IN 150mm LAYERS AND AS PER THE SPECIFICATION. WHERE THERE IS FILL IN EXCESS OF

SPECIFIED IN THE AUSTRALIAN STANDARD AS 3798 TO SHOW THAT LEVEL 1 COMPACTION STANDARDS HAVE BEEN

300mm IN DEPTH, THE CONTRACTOR IS TO CARRY OUT SOIL TESTS TO THE REQUIREMENTS OF APPENDIX B AS

14. FILL MATERIAL USED UNDER PAVEMENTS AND FOOTPATHS MUST BE AN APPROVED MATERIAL TO THE STANDARD OF WYNDHAM CITY COUNCIL. ALL SUCH MATERIAL IS TO BE COMPACTED AS PER THE REQUIREMENTS OF THE SPECIFICATION APPROVED WITH THESE DRAWINGS PRIOR TO FORMWORK BEING PLACED. COMPACTION TESTS TO

16. ALL ALLOTMENTS SHALL BE SMOOTHED, GRADED AND SHAPED TO AN EVEN SURFACE WITH A MINIMUM FALL OF 1 in

18. DRAINAGE PITS SHALL BE CAST MONOLITHICALLY. CEMENT RENDER SHALL ONLY BE USED TO REPAIR DEFECTS 19. BACKFILLING OF TRENCHES WHERE DRAINAGE AND SEWERAGE ARE IN CLOSE PROXIMITY ARE TO BE BACKFILLED

20. ALL SERVICING TRENCHES UNDER ROADS, FOOTPATHS, DRIVEWAYS, PARKING BAYS ETC. ARE TO BE BACKFILLED

ALL HOUSE DRAIN CONNECTIONS ARE TO BE LOCATED AT 6m FROM THE DRIVEWAY SIDE BOUNDARY U.NO. INVERT OF PROPERTY INLETS TO BE 500mm MINIMUM BELOW FINISHED SURFACE UNLESS NOTED OTHERWISE VEHICLE CROSSINGS TO BE CONSTRUCTED IN ACCORDANCE WITH STANDARD DRAWINGS EDCM 501 TO 503. DRIVEWAYS TO BE LOCATED MIN 0.75m FROM BUILDING LINE UNLESS SPECIFIED OTHERWISE AND CLEAR OF DRAINAGE PITS. SEWER MAINTENANCE HOLES AND EXISTING TREES, DOUBLE DRIVEWAY WIDTH TO BE 7.0m AT

 24 . ADDITIONAL AND OVER-EXCAVATION SHALL BE BACKFILLED IN ACCORDANCE WITH THE PROVISIONS OF THE

27. ALL EXOTIC (NON NATIVE) TREES AND SHRUBS, INCLUDING DEAD TREES, NOT SHOWN ON THE DRAWINGS BUT

28. INSTALL BLUE RAISED REFLECTIVE PAVEMENT MARKER (BRRPM) ON ROAD CENTRELINE AND "GROUND BALL"

 29 . THE CONTRACTOR IS TO ENSURE THAT THEIR CONSTRUCTION PROCEDURES AND STANDARDS CONTROL THE

30. UPON COMPLETION OF CONSTRUCTION THE WHOLE SITE SHALL BE CLEANED UP, GRADED AND ALL RUBBISH

31. EXISTING PAVEMENT OR DRAINAGE WORKS DAMAGED DURING CONSTRUCTION OR THE MAINTENANCE PERIOD TO

THE LOWER SUB-BASE MATERIAL SHALL WILL BE N.D.C.R. FOR PAVEMENT MAKE UPS AS PER THE STANDARD

ALL STORMWATER DRAINAGE PIPES SHALL NOT BE SUBJECTED TO CONSTRUCTION TRAFFIC LOADING DURING CONSTRUCTION UNLESS THE PIPE STRENGTH CHARACTERISTICS HAVE BEEN COMPUTED AND APPROVED BY THE CONTRACTORS ENGINEER. COMPUTATIONS ARE TO ACCORD WITH AS.3725-2007, LOADS ON BURIED PIPES. CONCRETE PIPES DAMAGED DUE TO CONSTRUCTION LOADS SHALL BE REPLACED & RELAID AT THE CONTRACTOR'S

ALL FOOTPATHS AND SHARED PEDESTRIAN/BICYCLE PATHS ARE TO BE CONSTRUCTED AS PER CITY OF WYNDHAM

VOLUME AND LOCATION FOR COLLECTION OF SEDIMENT RUNOFF ACCORDING TO CURRENT EPA - ENVIRONMENTAL

17. ALL DRAINAGE PIPES ARE CLASS 2 RCP PIPES, RUBBER RING JOINTED UNLESS OTHERWISE SPECIFIED.

ACHIEVED. TEST RESULTS AND LOCATION OF TESTS FOR EACH ALLOTMENT SHALL BE APPROVED BY THE

OF WATER, GAS OR SEWER PIPES OR WITHIN 15m OF ANY COMPLETED PART OF THE WORKS WITHOUT THE

10. ALL LINEMARKING, SIGNING AND TRAFFIC CONTROL DEVICES TO BE IN ACCORDANCE WITH VICROADS

SAFETY MEASURES REQUIRED Please note there are risks attached to the construction of this project, and any ongoing maintenance of structures. onsider the safety of all. For potential risks, consequences and controls refer to Safety In Design Risk Register SID P4.E6. 2360E-011-500

WARNING

BEWARE OF UNDERGROUND SERVICES The locations of underground services are approximate only and their exact position should be proven on site. No guarantee is given that all existing services are shown. Locate all underground services before commencement of works DIAL 1100 BEFORE YOU DIG www.1100.com.au

01 of 19

Road and Drainage

AS CONSTRUCTED PLANS


The purpose of these as-constructed plans is to update the design drawings to show significant changes which occurred during construction. Note that the levels shown on these plans are design levels, and have not been verified by survey. All information shown on these plans should be verified on site. SMEC Australia Pty Ltd accept no responsibility for loss or damages resulting from the inappropriate usage of these plans.






AS CONSTRUCTED



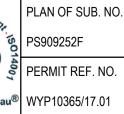

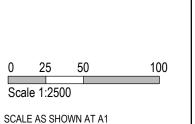





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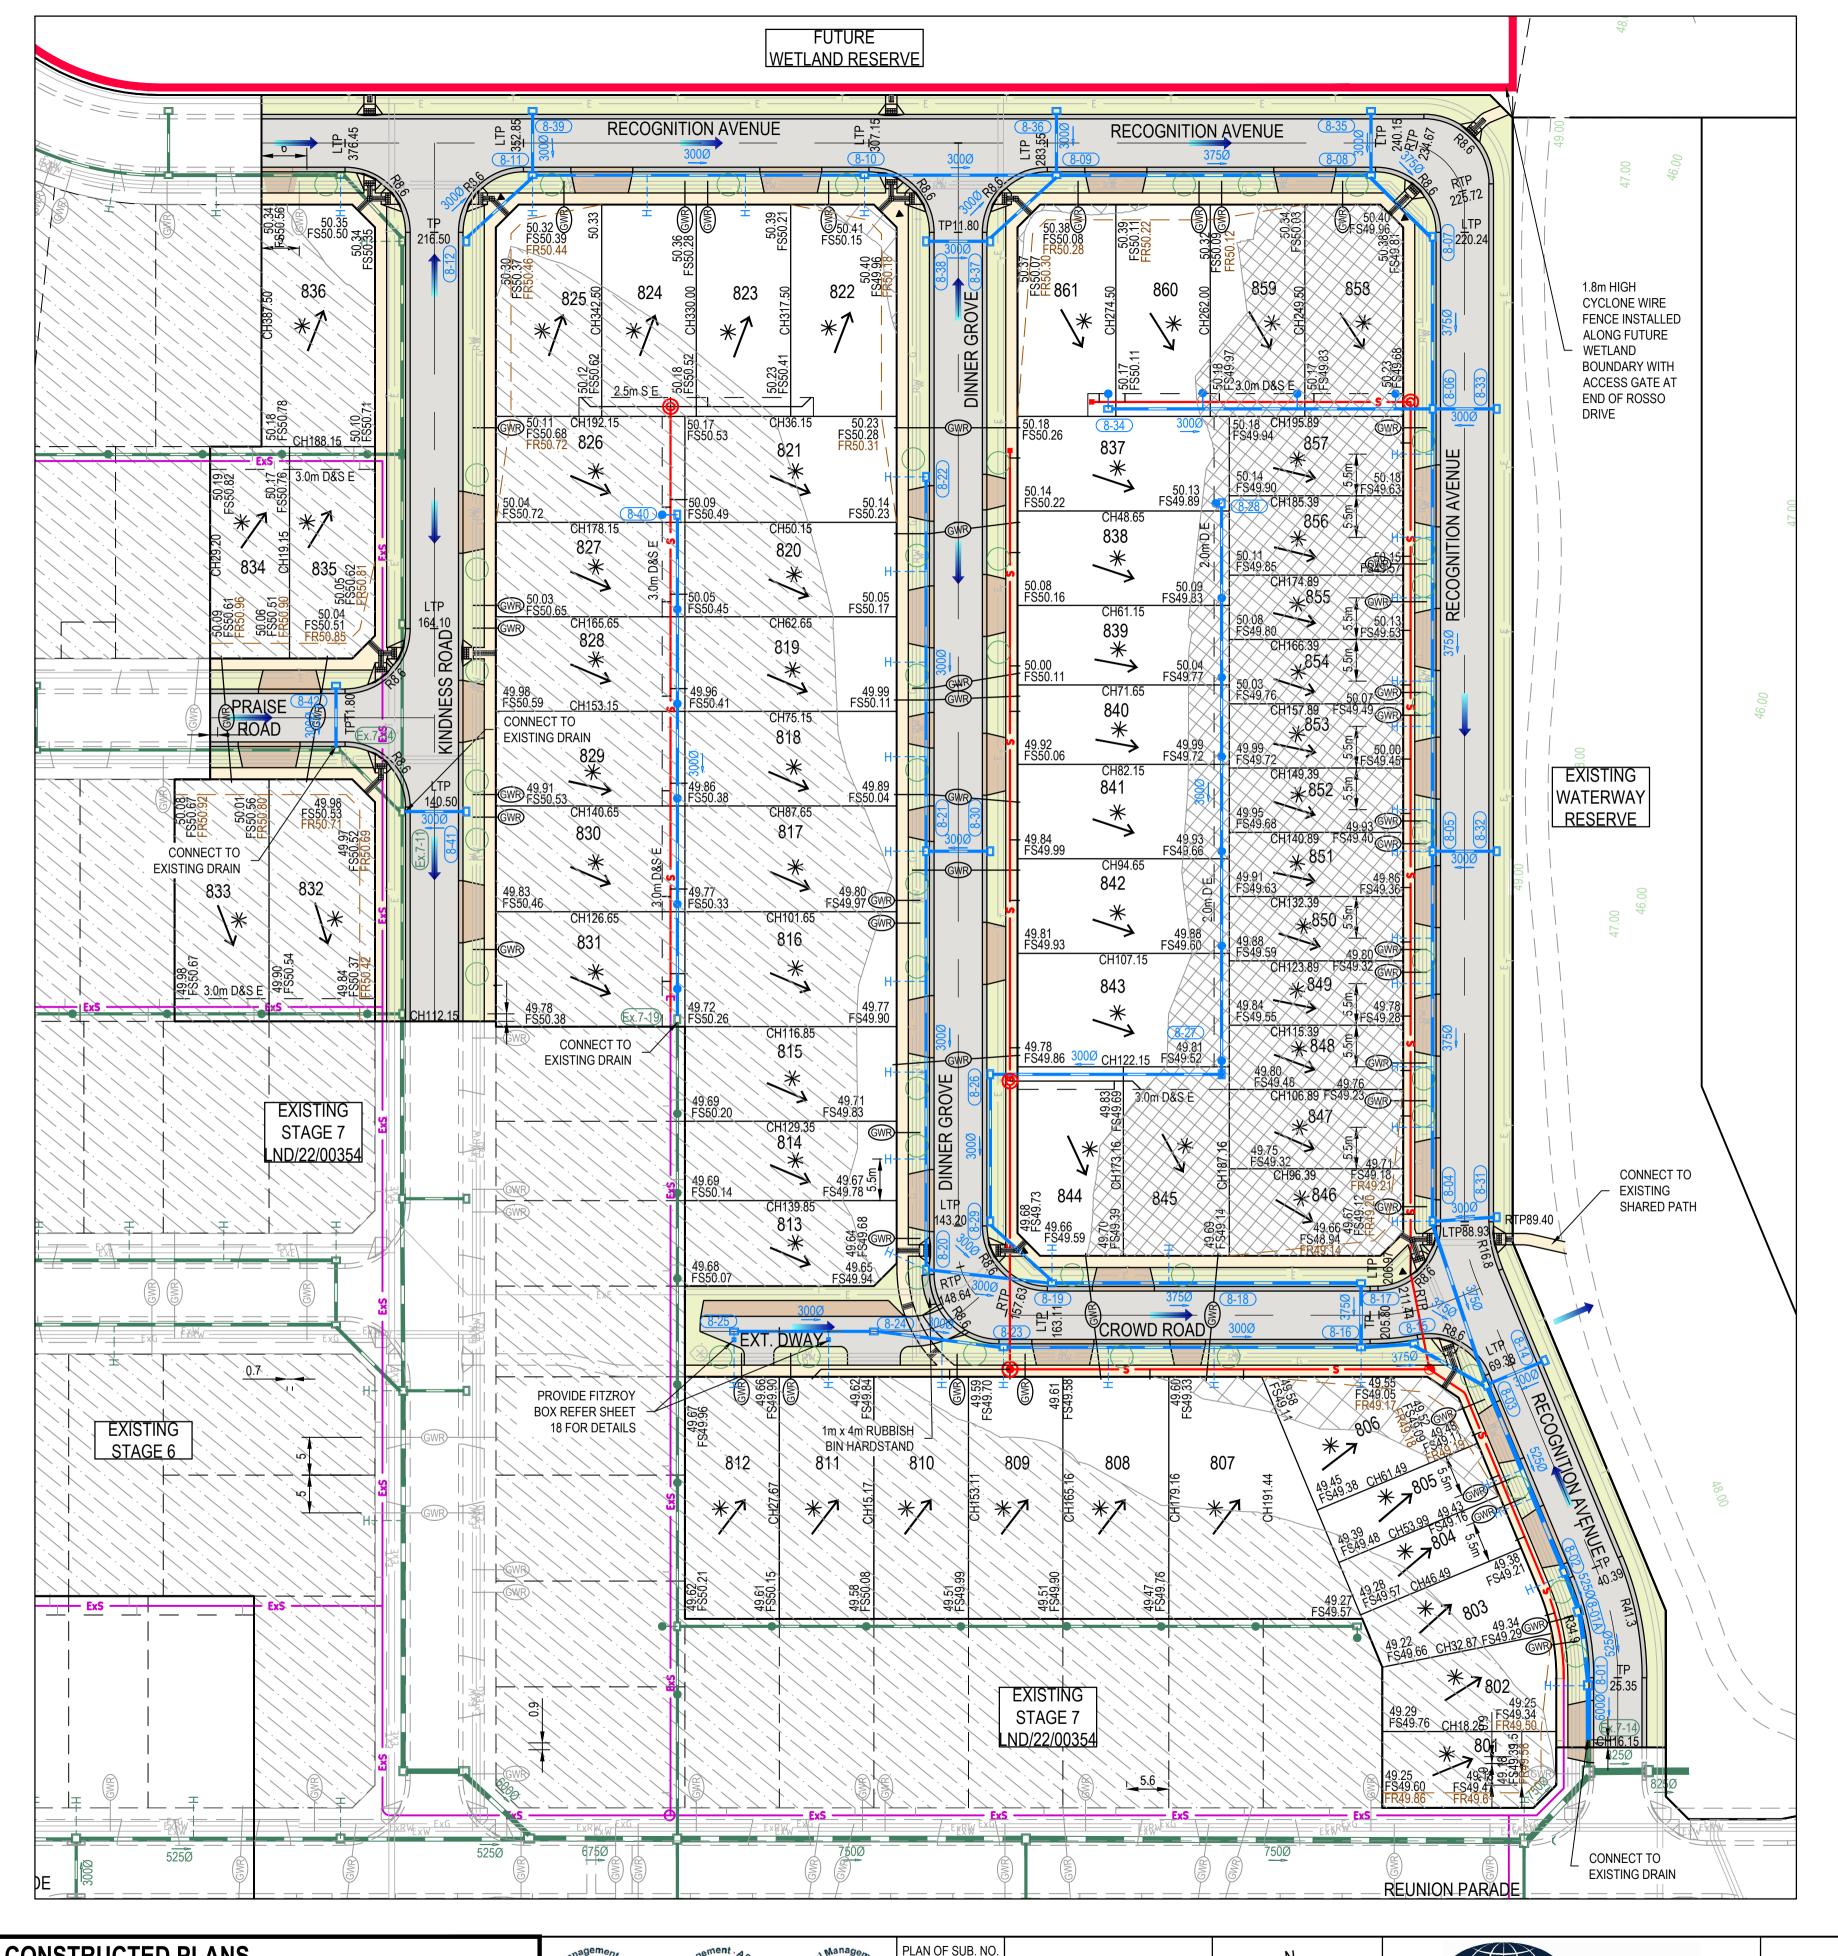


Marigold - Stage 8 Wyndham City Council Cover Plan, General Notes & Typical Cross Sections

GROWLAND

MELWAYS REF PROJECT / DRAWING No. 2360E-008-101

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EXISTING RETAINING WALL FUTURE RETAINING WALL STRUCTURAL FILL > 200mm DEEP EXISTING STRUCTURAL FILL > 200mm DEEP CUT > 200mm DEEP DIRECTION OF FALL OVERLAND FLOW GRADED IN DIRECTION OF FALL TO LEVEL INDICATED EDGE STRIP, SUBSOIL DRAIN, "NO ROAD" SIGN & BARRIER **EXISTING TREE** TO BE RETAINED EXISTING TREE TO BE REMOVED PERMANENT SURVEY MARK TEMPORARY BENCH MARK PROPOSED DRIVEWAY & FOOTPATH PROPOSED INDUSTRIAL DRIVEWAY PROPOSED SHARED FOOTPATH PROPOSED ROAD PAVING EXISTING ROAD PAVING CYCLONE WIRE FENCE WARNING
BEWARE OF UNDERGROUND SERVICES their exact position should be proven on site. No guarantee is given that all existing services are shown. cate all underground services before commencement of works **DIAL 1100 BEFORE YOU DIG** www.1100.com.au

LEGEND - LAYOUT PLAN

ALL PROPOSED, FUTURE & EXISTING SERVICE LOCATIONS ARE SHOWN INDICATIVELY

STORMWATER DRAIN, PIT & PROPERTY INLET

SEWER & MAINTENANCE STRUCTURES

ELECTRICITY (U.GROUND)

MAIN DRAIN

—0/H — | ELECTRICITY (O.HEAD)

OPTIC FIBRE

AG. DRAIN

EXISTING MAIN DRAIN

RECYCLE WATER

SERVICE CONDUITS

EXISTING SWALE DRAIN

EXISTING HOUSE DRAIN

EXISTING SEWER & MAINTENANCE

EXISTING ELECTRICITY OVERHEAD

EXISTING ELECTRICITY (UNDER GROUND)

TACTILE PAVERS

EXISTING STORMWATER DRAIN

STRUCTURES

EXISTING GAS

EXISTING TELSTRA

EXISTING WATER

EXISTING TACTILE PAVERS

☐─Fuf ☐ ── | FUTURE STORMWATER DRAIN

STRUCTURES

FUTURE GAS

FUTURE TELSTRA FUTURE OPTIC FIBRE

FUTURE WATER

FUTURE AG. DRAIN

ZERO LOT LINES

| FUTURE RECYCLED WATER

FUTURE SERVICE CONDUITS FUTURE TACTILE PAVERS

EXISTING SURFACE LEVEL

FINISHED BUILDING LINE LEVEL FINISHED RIDGE LINE LEVEL

TOP OF RETAINING WALL LEVEL BOTTOM OF RETAINING WALL LEVEL

EXISTING AG. DRAIN

FUTURE MAIN DRAIN

FUTURE SWALE DRAIN

FUTURE HOUSE DRAIN

EXISTING OPTIC FIBRE

EXISTING RECYCLED WATER

EXISTING SERVICE CONDUITS

FUTURE SEWER & MAINTENANCE

FUTURE ELECTRICITY OVERHEAD

FUTURE ELECTRICITY (UNDER GROUND)

----- w ------ | WATER

 $-\overline{\text{GW}}$

⊖—**E**x **S** —

—0/H E —

——Ex G ——

<u>—</u>Ех Т — —Ex 0 —

—Ex W —

—Ex.Ag —

O-FUT S -

-FutO/H E -

—Fut G —

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SWALE DRAIN

AS CONSTRUCTED PLANS


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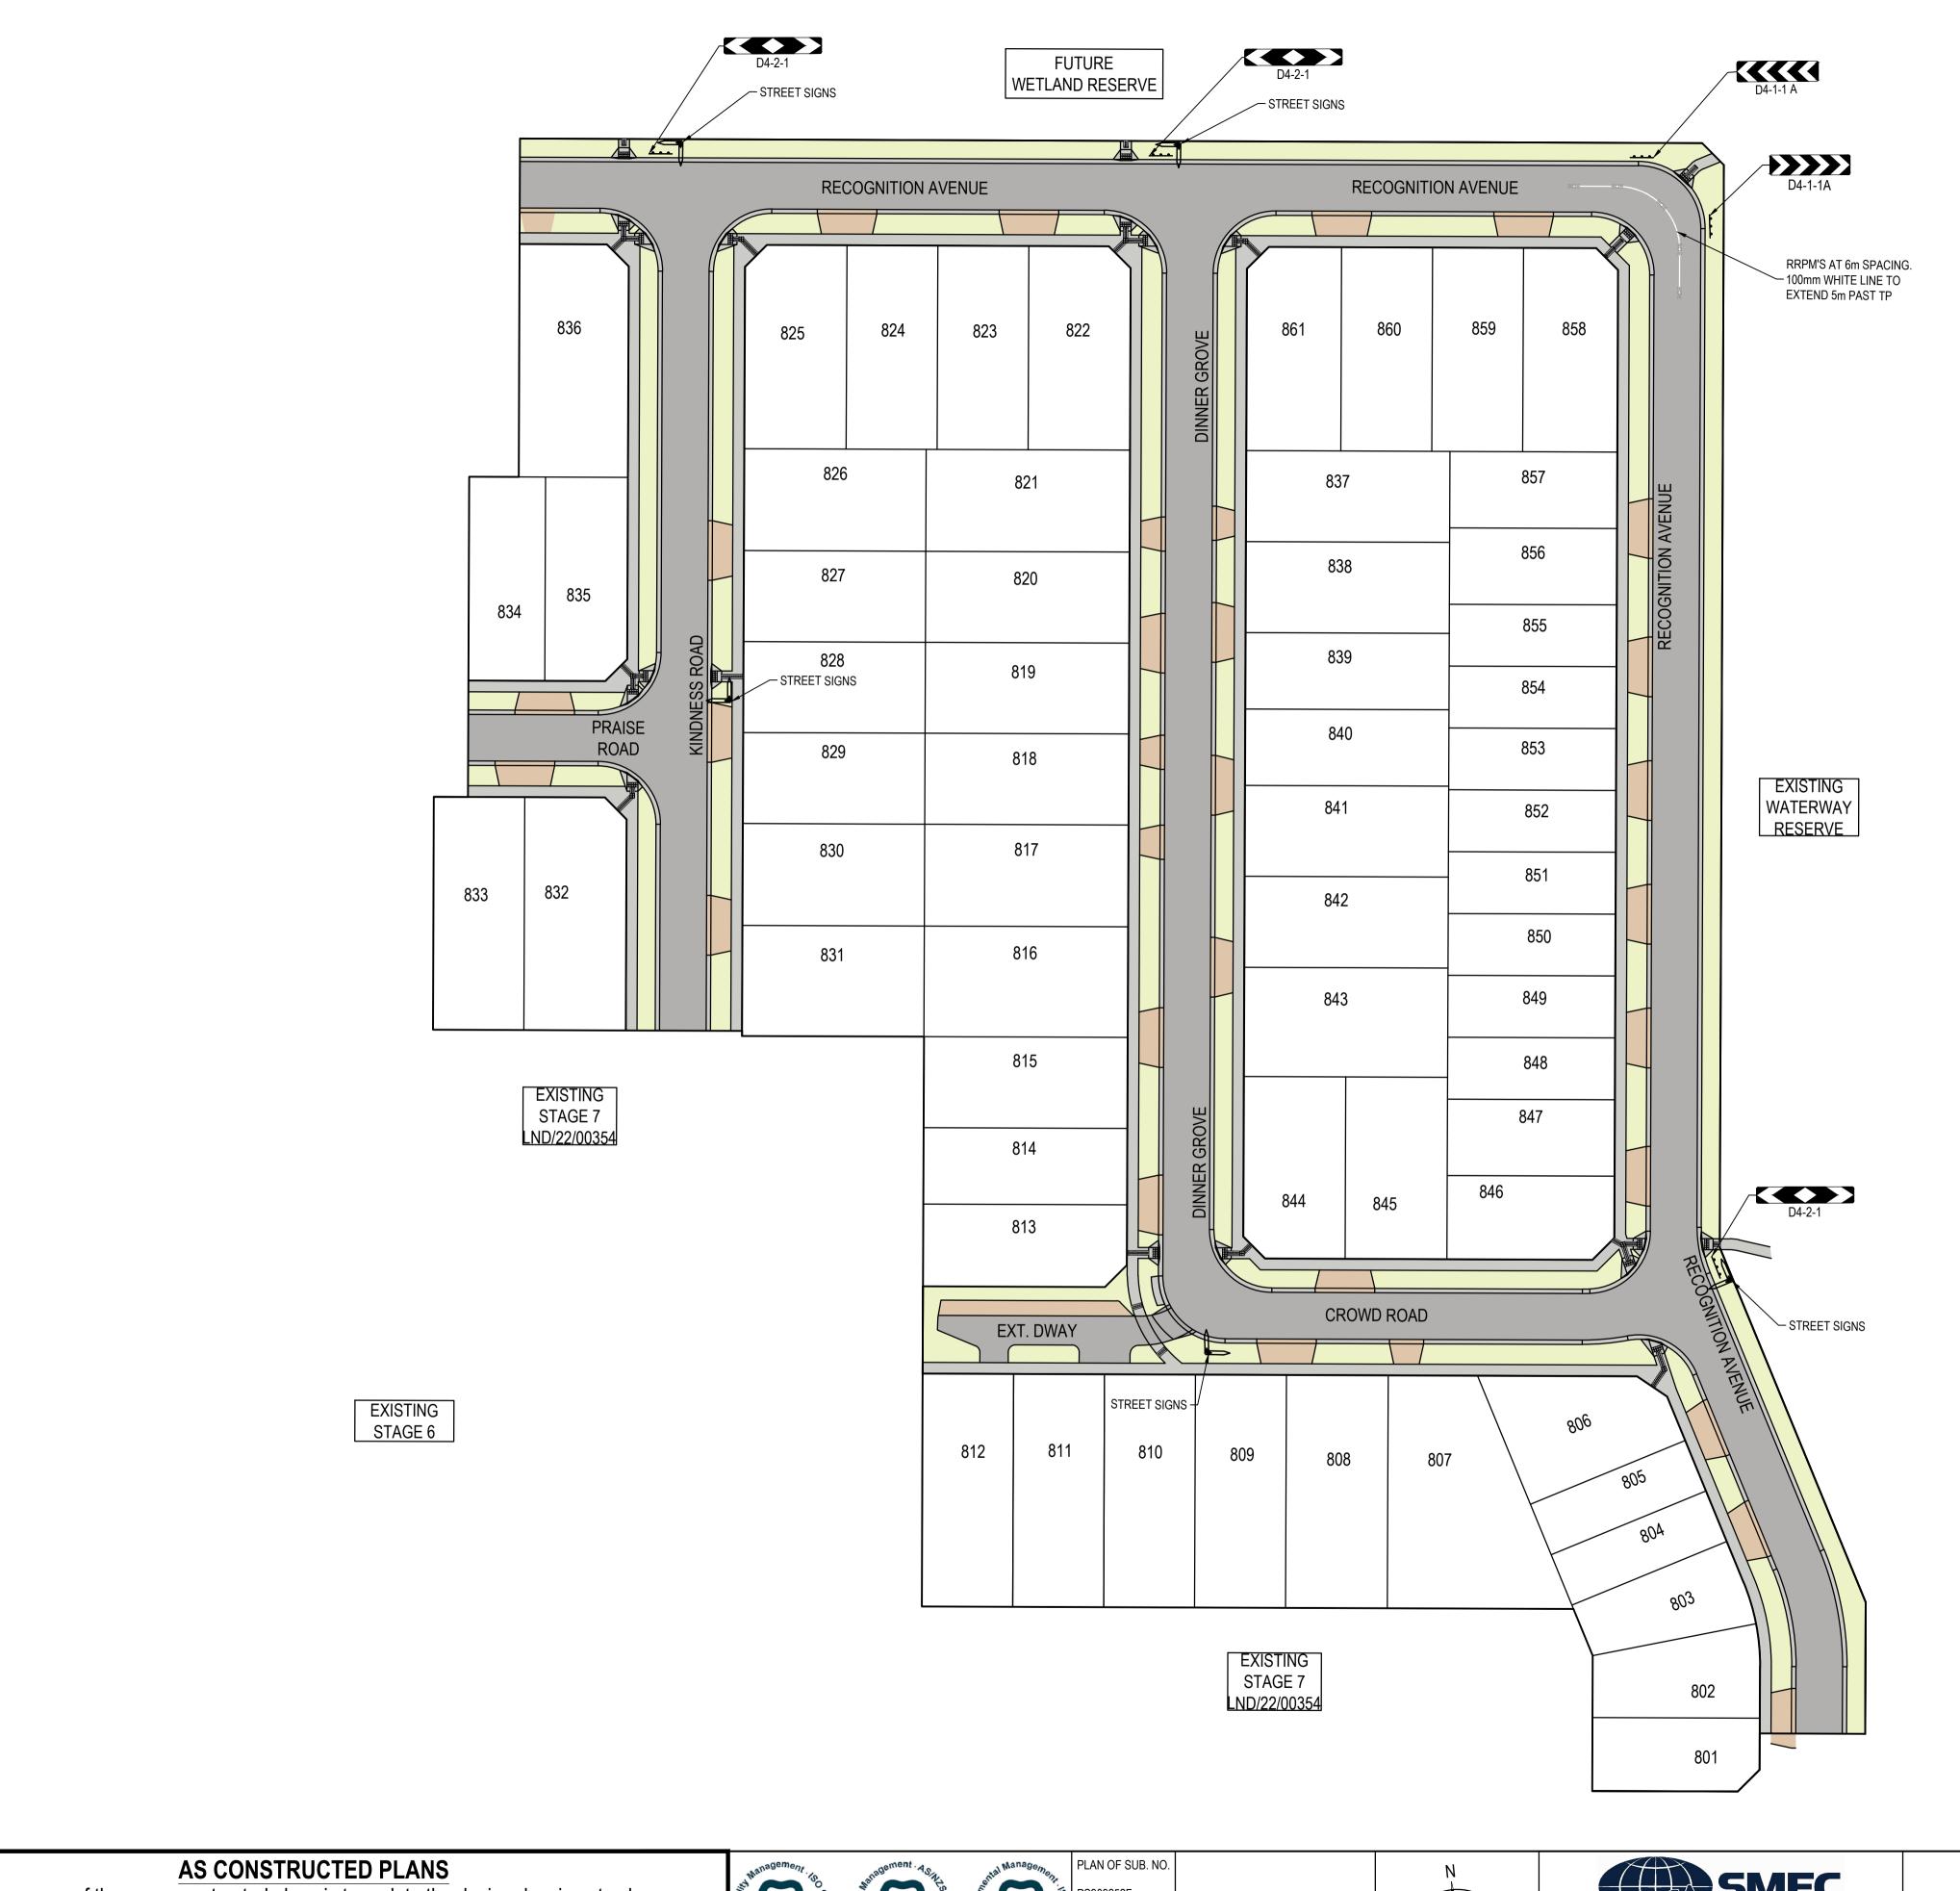






Marigold - Stage 8
Wyndham City Council
Road and Drainage Layout Plan

PROJECT / DRAWING No. 2360E-008-111 02 of 19

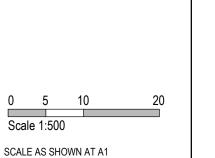

WARNING BEWARE OF UNDERGROUND SERVICES

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DIAL 1100 BEFORE YOU DIG


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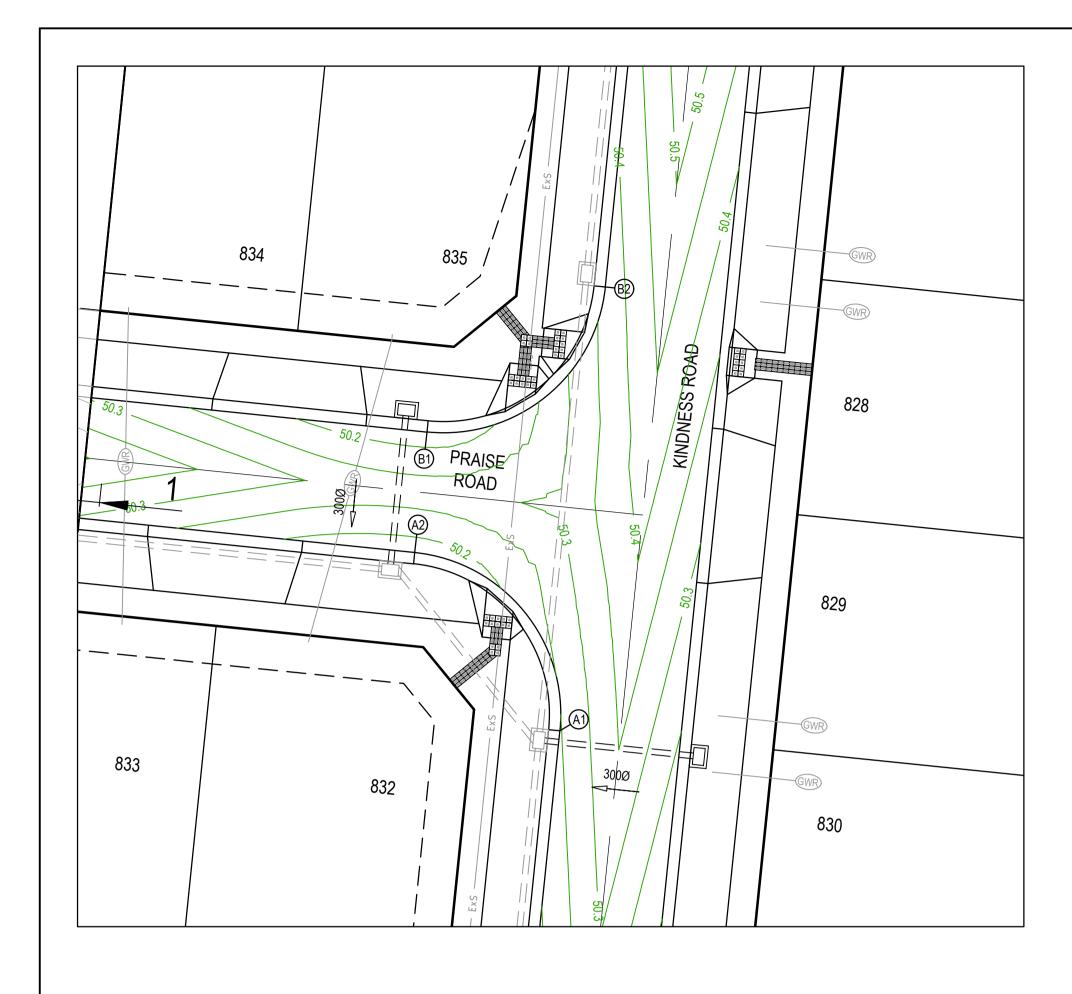









Marigold - Stage 8
Wyndham City Council
Road and Drainage
Signage & Linemarking Plan


MELWAYS REF PROJECT / DRAWING No. 2360E-008-171

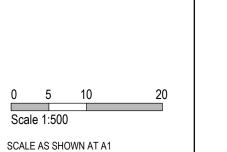


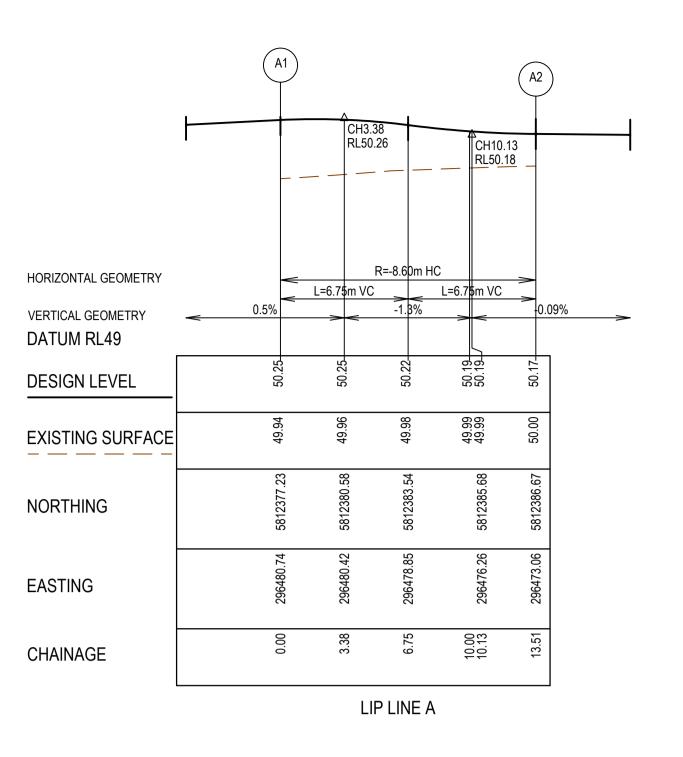


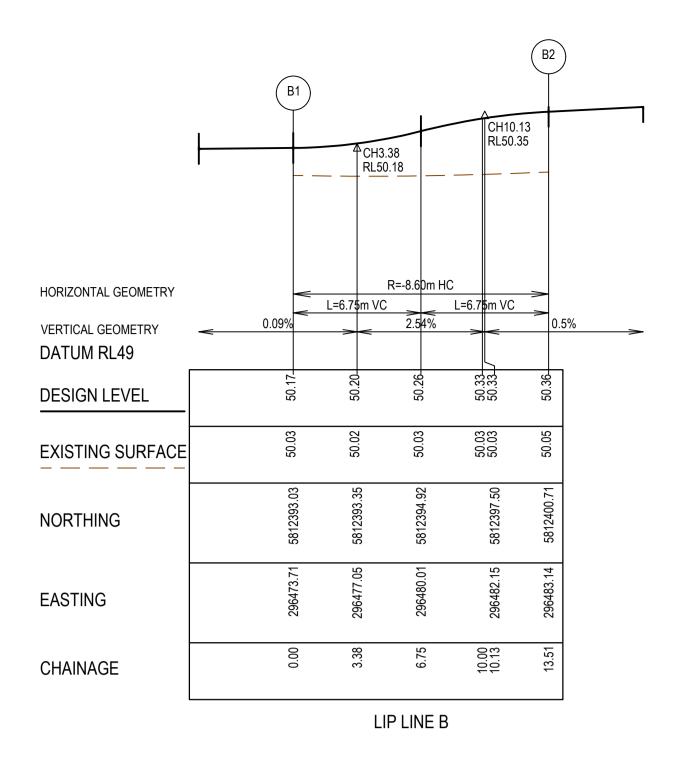

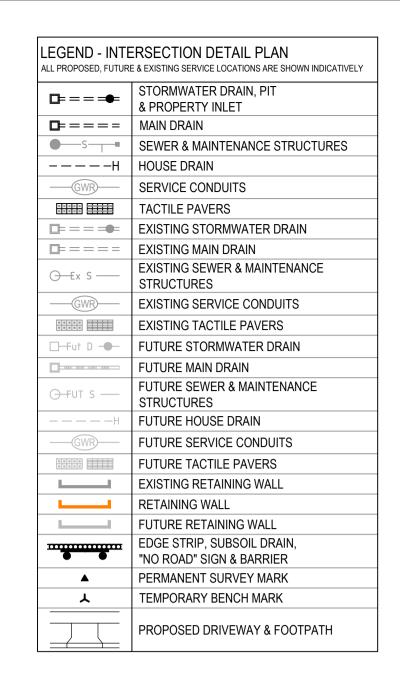

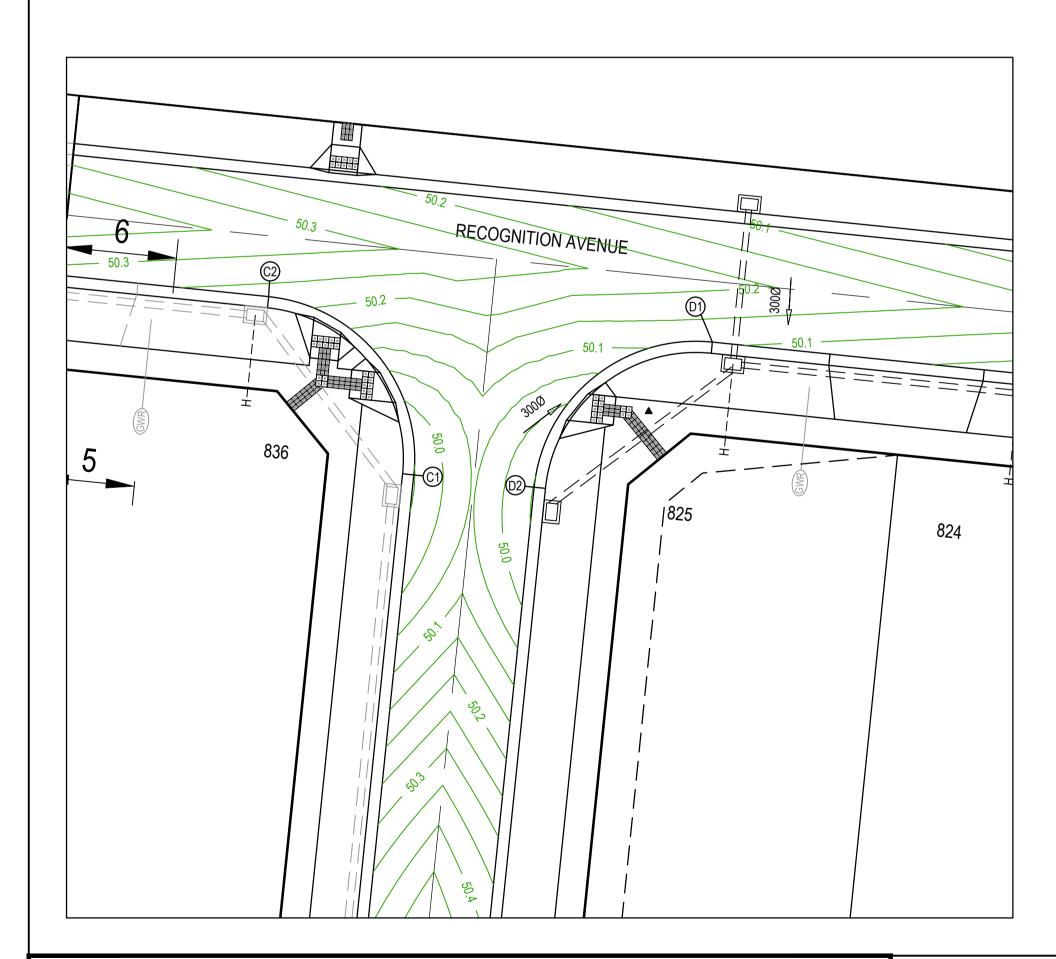

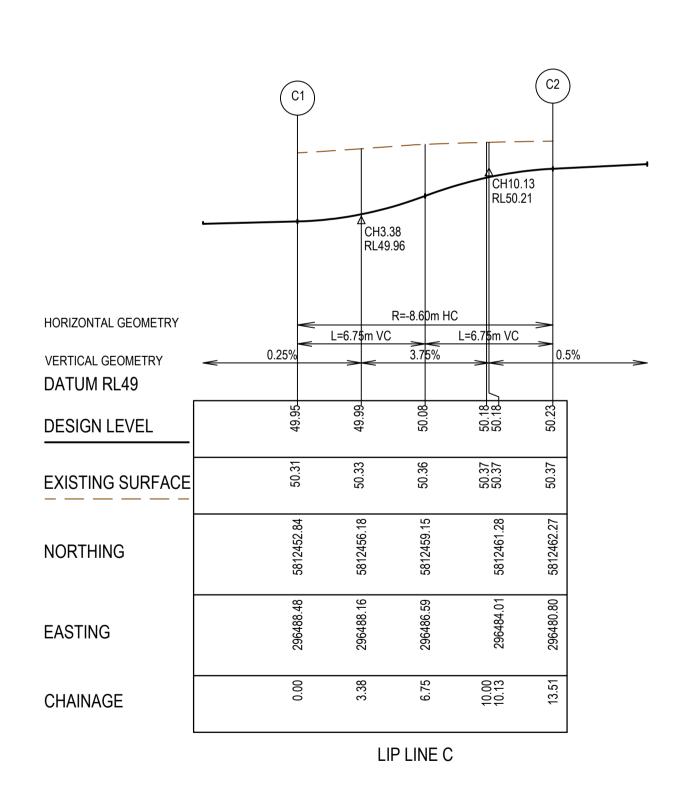

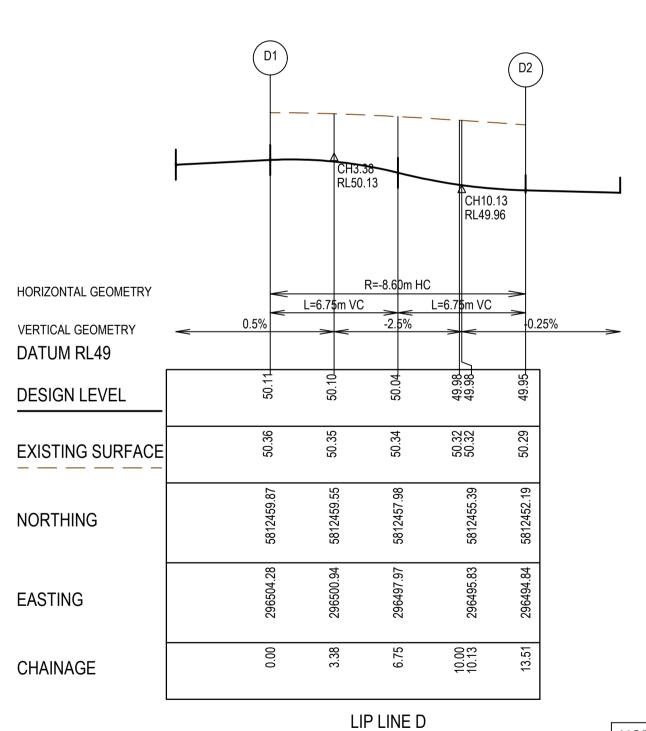

ALL VEHICLE CROSSINGS AND PRAM CROSSINGS TO BE MINIMUM OF 0.75m FROM PITS.
ALL PRAM CROSSINGS TO BE MINIMUM OF 2.0m FROM VEHICLE CROSSINGS.

SHARE PATH THROUGH CREEK CORRIDOR TO FORM PART OF LANDSCAPE WORKS.

- VEHICLE EXCLUSION MEASURES BETWEEN ROAD RESERVE AND RESERVE TO FORM PART OF THE LANDSCAPE WORKS.
- INDUSTRIAL DRIVEWAYS TO COUNCIL RESERVES TO BE PROVIDED AS PART OF LANDSCAPE WORKS.

AS CONSTRUCTED PLANS

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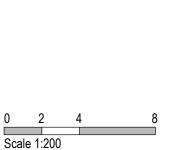





AS CONSTRUCTED







SCALE AS SHOWN AT A1

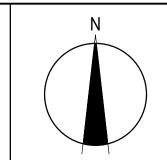





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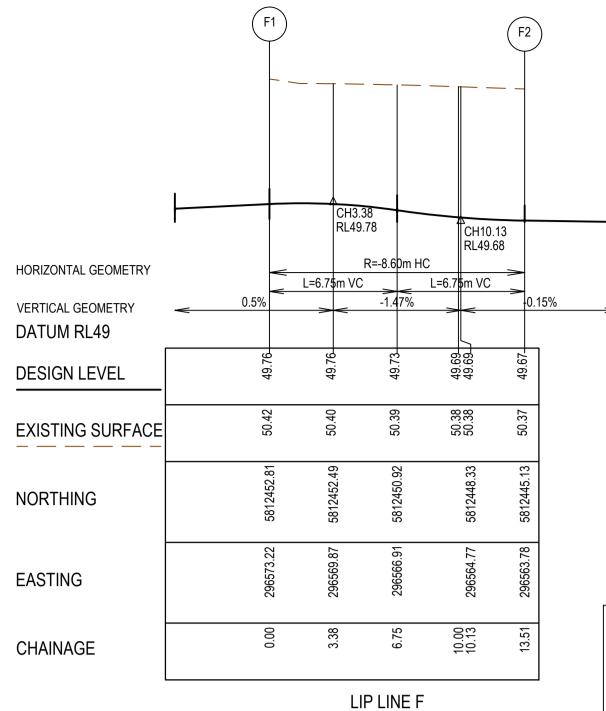


Marigold - Stage 8
Wyndham City Council
Road and Drainage
Intersection Detail Plan - 1

MELWAYS REF 359 F9 2360E-008-181




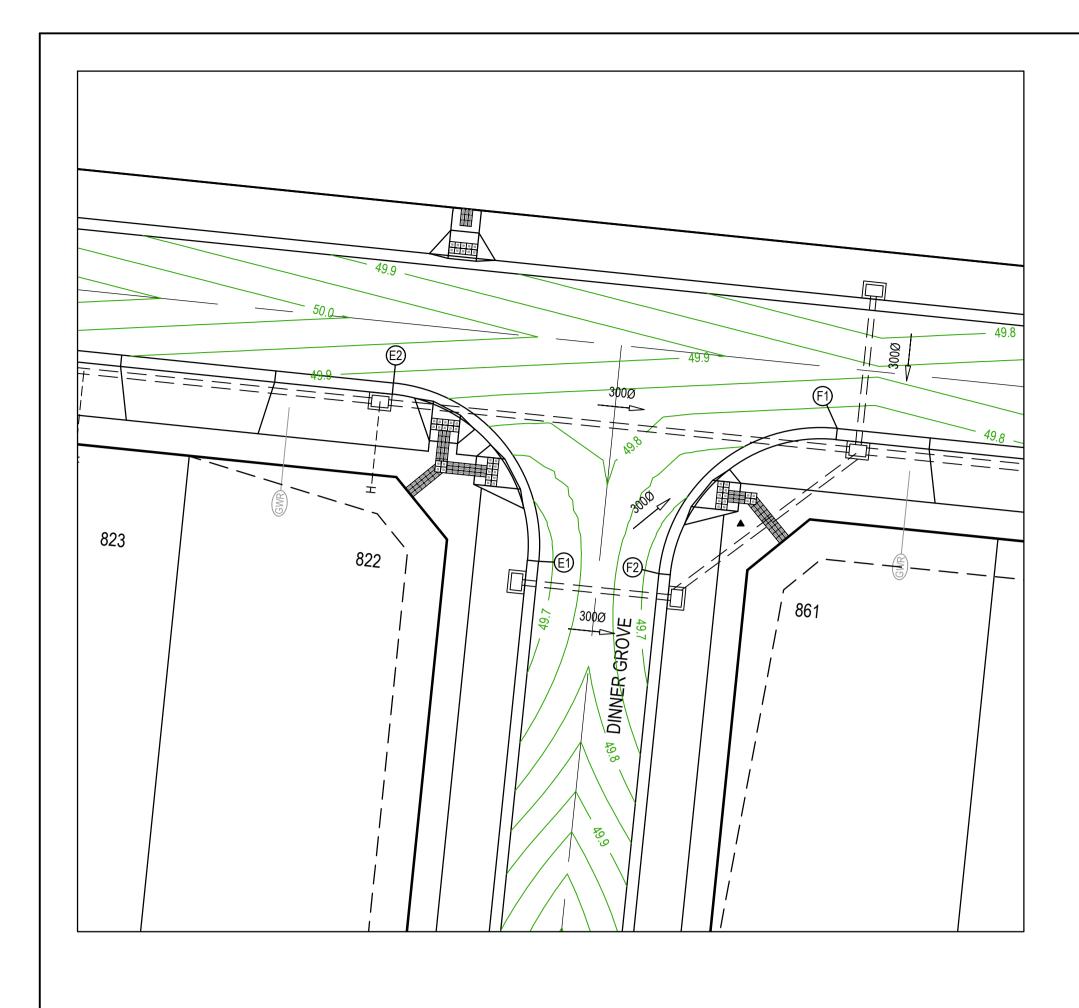


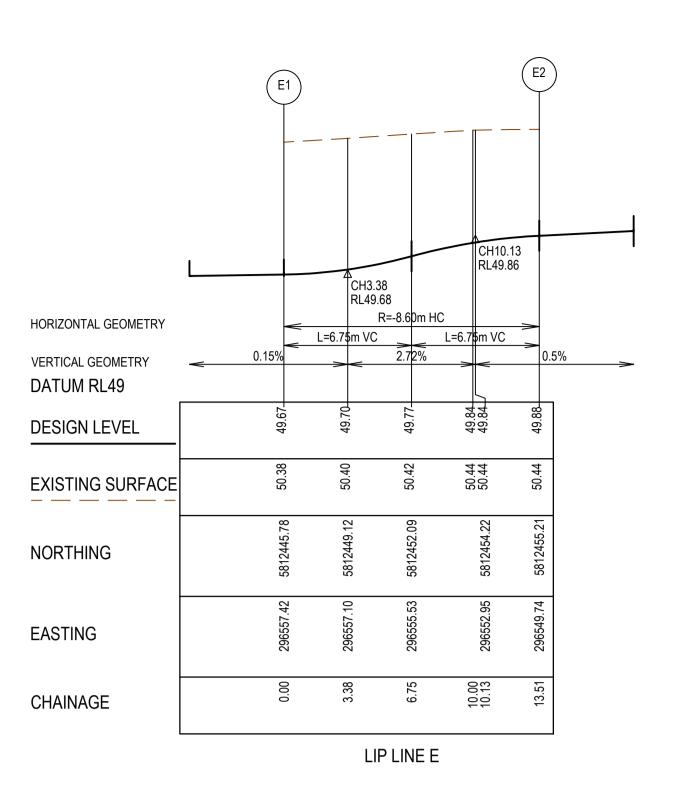


LEGEND - INTERSECTION DETAIL PLAN ALL PROPOSED, FUTURE & EXISTING SERVICE LOCATIONS ARE SHOWN INDICATIVELY STORMWATER DRAIN, PIT & PROPERTY INLET $\square = = = = |$ MAIN DRAIN SEWER & MAINTENANCE STRUCTURES ----H HOUSE DRAIN SERVICE CONDUITS TACTILE PAVERS □= = = ■ EXISTING STORMWATER DRAIN □= = = = | EXISTING MAIN DRAIN **EXISTING SEWER & MAINTENANCE** O—Ex S — STRUCTURES EXISTING SERVICE CONDUITS EXISTING TACTILE PAVERS ☐─Fuf D ─── | FUTURE STORMWATER DRAIN FUTURE MAIN DRAIN FUTURE SEWER & MAINTENANCE O-FUT S -STRUCTURES FUTURE HOUSE DRAIN FUTURE SERVICE CONDUITS 0 0 0 0 0 FUTURE TACTILE PAVERS EXISTING RETAINING WALL RETAINING WALL FUTURE RETAINING WALL EDGE STRIP, SUBSOIL DRAIN, "NO ROAD" SIGN & BARRIER PERMANENT SURVEY MARK TEMPORARY BENCH MARK PROPOSED DRIVEWAY & FOOTPATH

- ALL VEHICLE CROSSINGS AND PRAM CROSSINGS TO BE MINIMUM OF 0.75m FROM PITS. ALL PRAM CROSSINGS TO BE MINIMUM OF 2.0m FROM VEHICLE CROSSINGS.
- VEHICLE EXCLUSION MEASURES BETWEEN ROAD RESERVE AND RESERVE TO FORM PART OF THE LANDSCAPE WORKS.
- INDUSTRIAL DRIVEWAYS TO COUNCIL RESERVES TO BE PROVIDED AS PART OF
- SHARE PATH THROUGH CREEK CORRIDOR TO FORM PART OF LANDSCAPE WORKS.

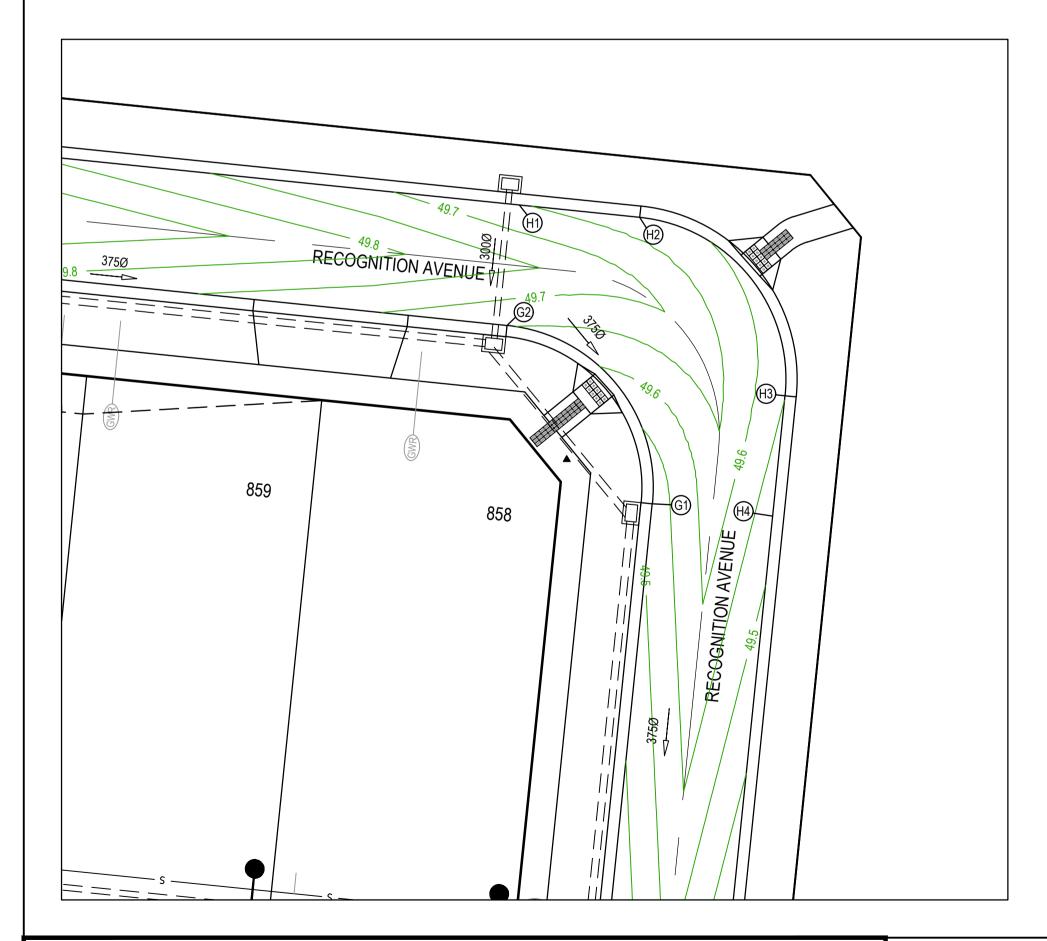

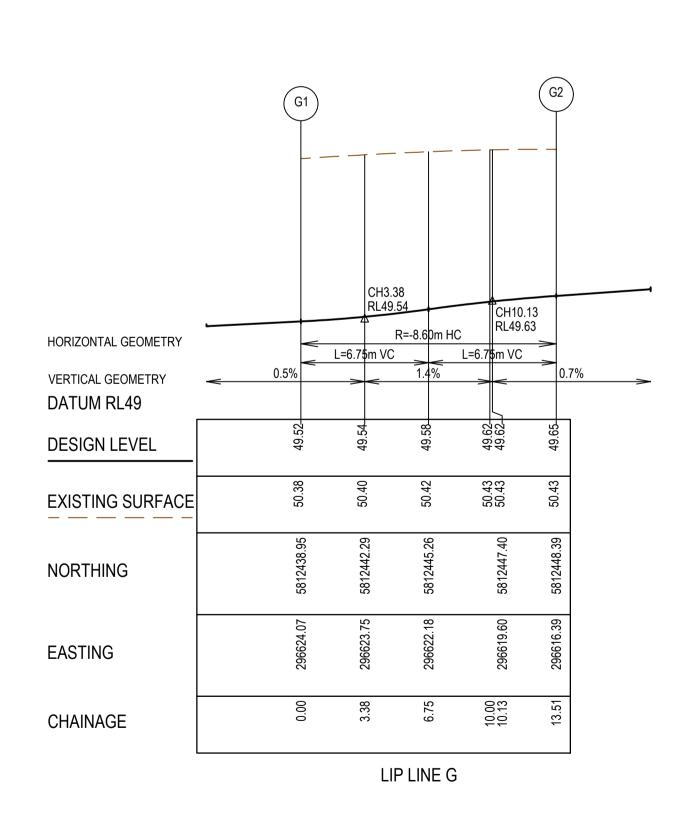

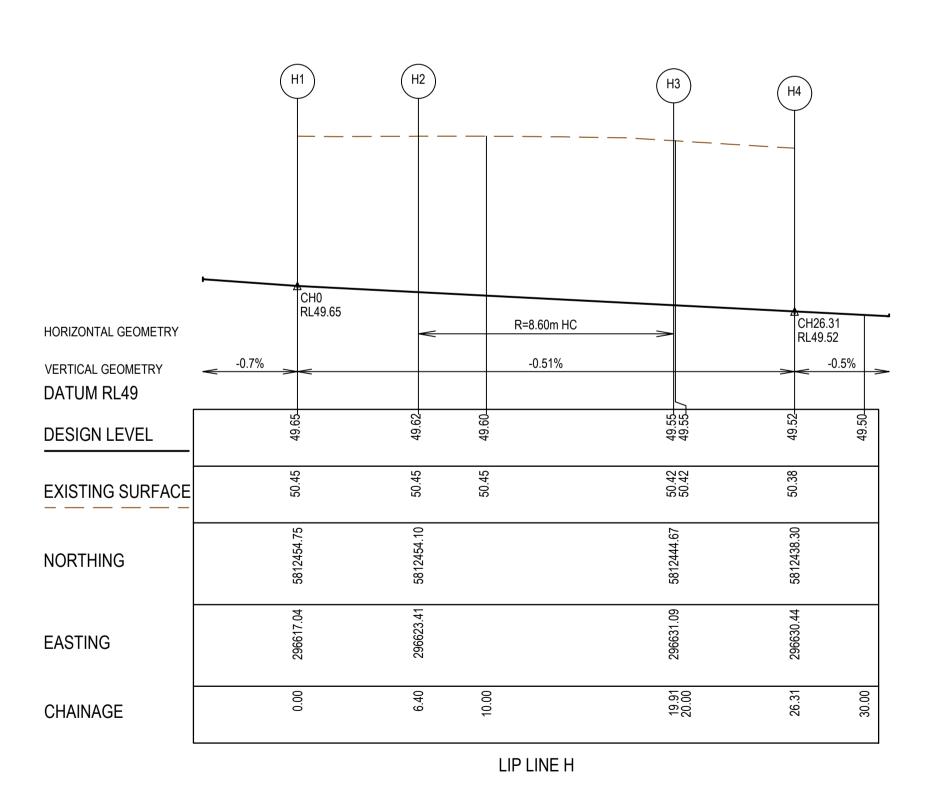

AS CONSTRUCTED PLANS


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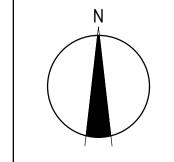
AS CONSTRUCTED







SCALE AS SHOWN AT A1

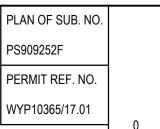








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Wyndham City Council
Road and Drainage Intersection Detail Plan - 2


MELWAYS REF PROJECT / DRAWING No. 2360E-008-182

GROWLAND 06 of 19

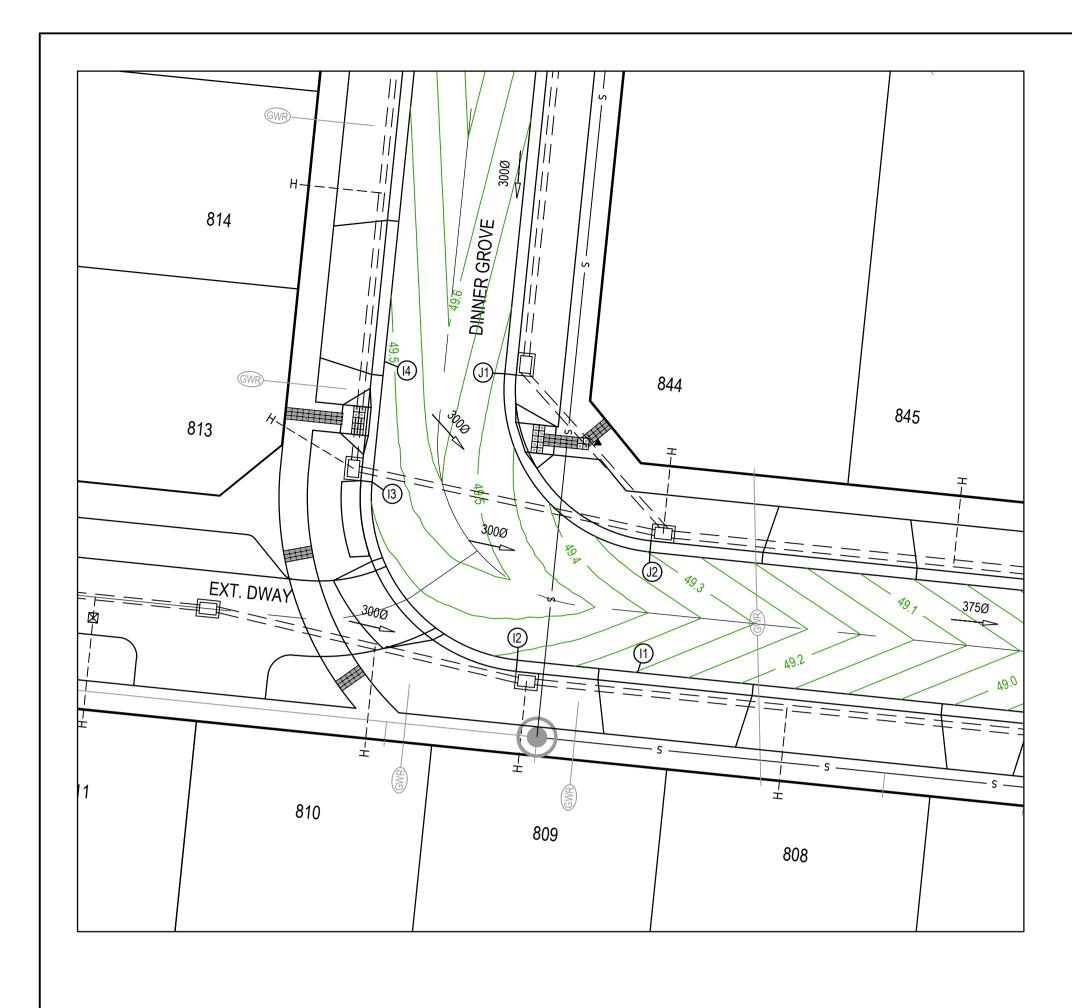

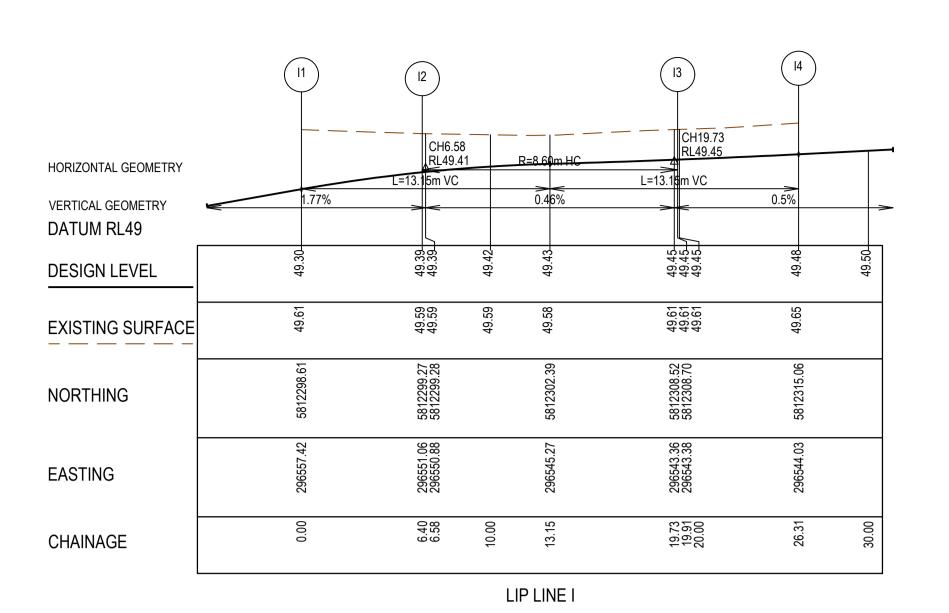

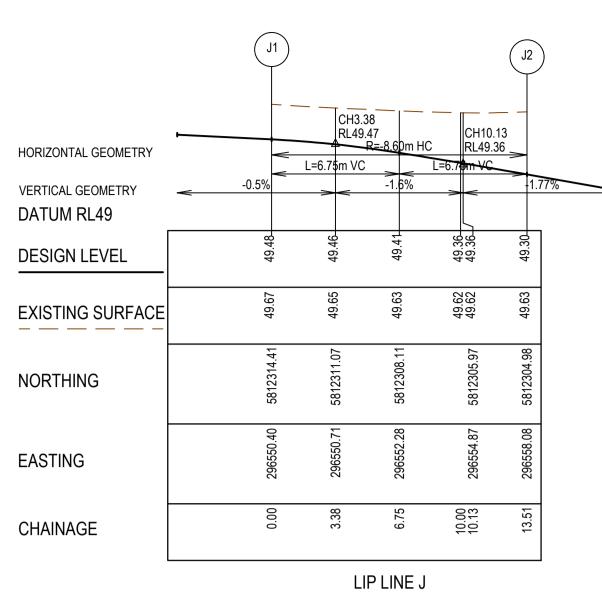


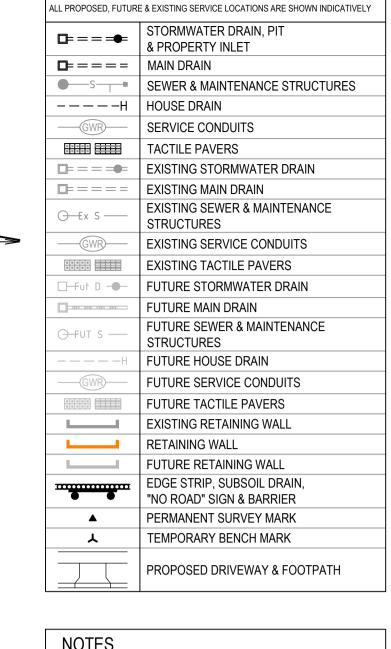


LEGEND - INTERSECTION DETAIL PLAN

- 1. ALL VEHICLE CROSSINGS AND PRAM CROSSINGS TO BE MINIMUM OF 0.75m FROM PITS.
- 2. ALL PRAM CROSSINGS TO BE MINIMUM OF 2.0m FROM VEHICLE CROSSINGS.
- 3. VEHICLE EXCLUSION MEASURES BETWEEN ROAD RESERVE AND RESERVE TO FORM PART OF THE LANDSCAPE WORKS.
- 4. INDUSTRIAL DRIVEWAYS TO COUNCIL RESERVES TO BE PROVIDED AS PART OF LANDSCAPE WORKS.
- 5. SHARE PATH THROUGH CREEK CORRIDOR TO FORM PART OF LANDSCAPE WORKS.

CROWD ROAD

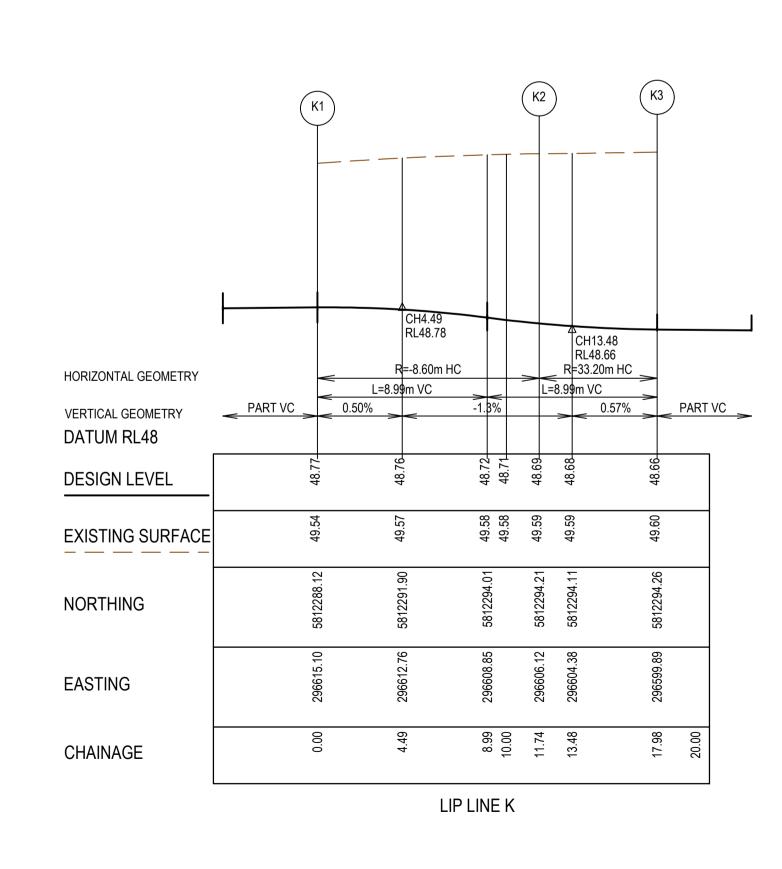

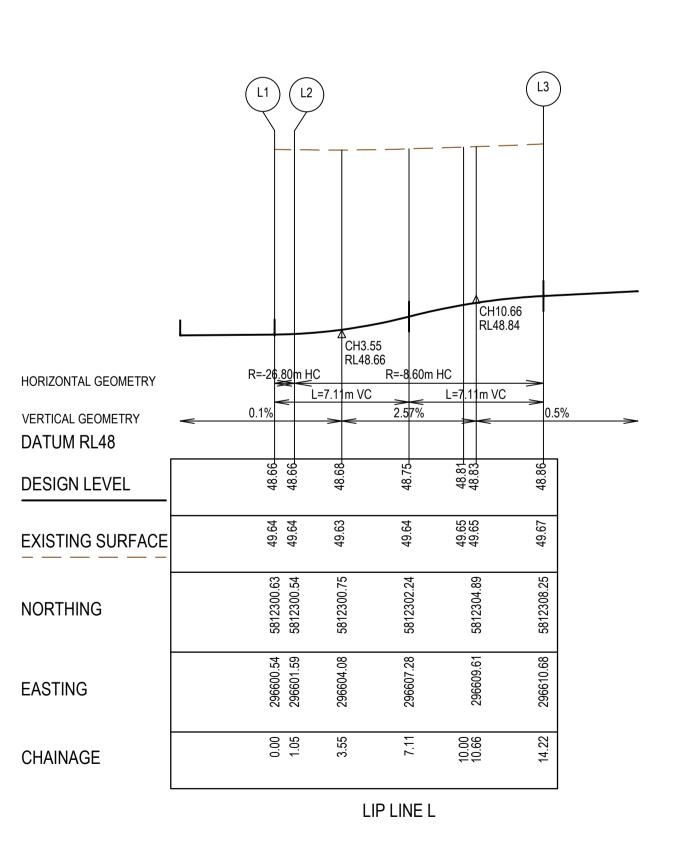

AS CONSTRUCTED PLANS


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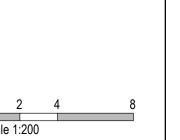


AS CONSTRUCTED





SCALE AS SHOWN AT A1

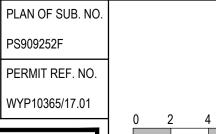










Marigold - Stage 8
Wyndham City Council
Road and Drainage Intersection Detail Plan - 3

MELWAYS REF PROJECT / DRAWING No. 2360E-008-183 07 of 19

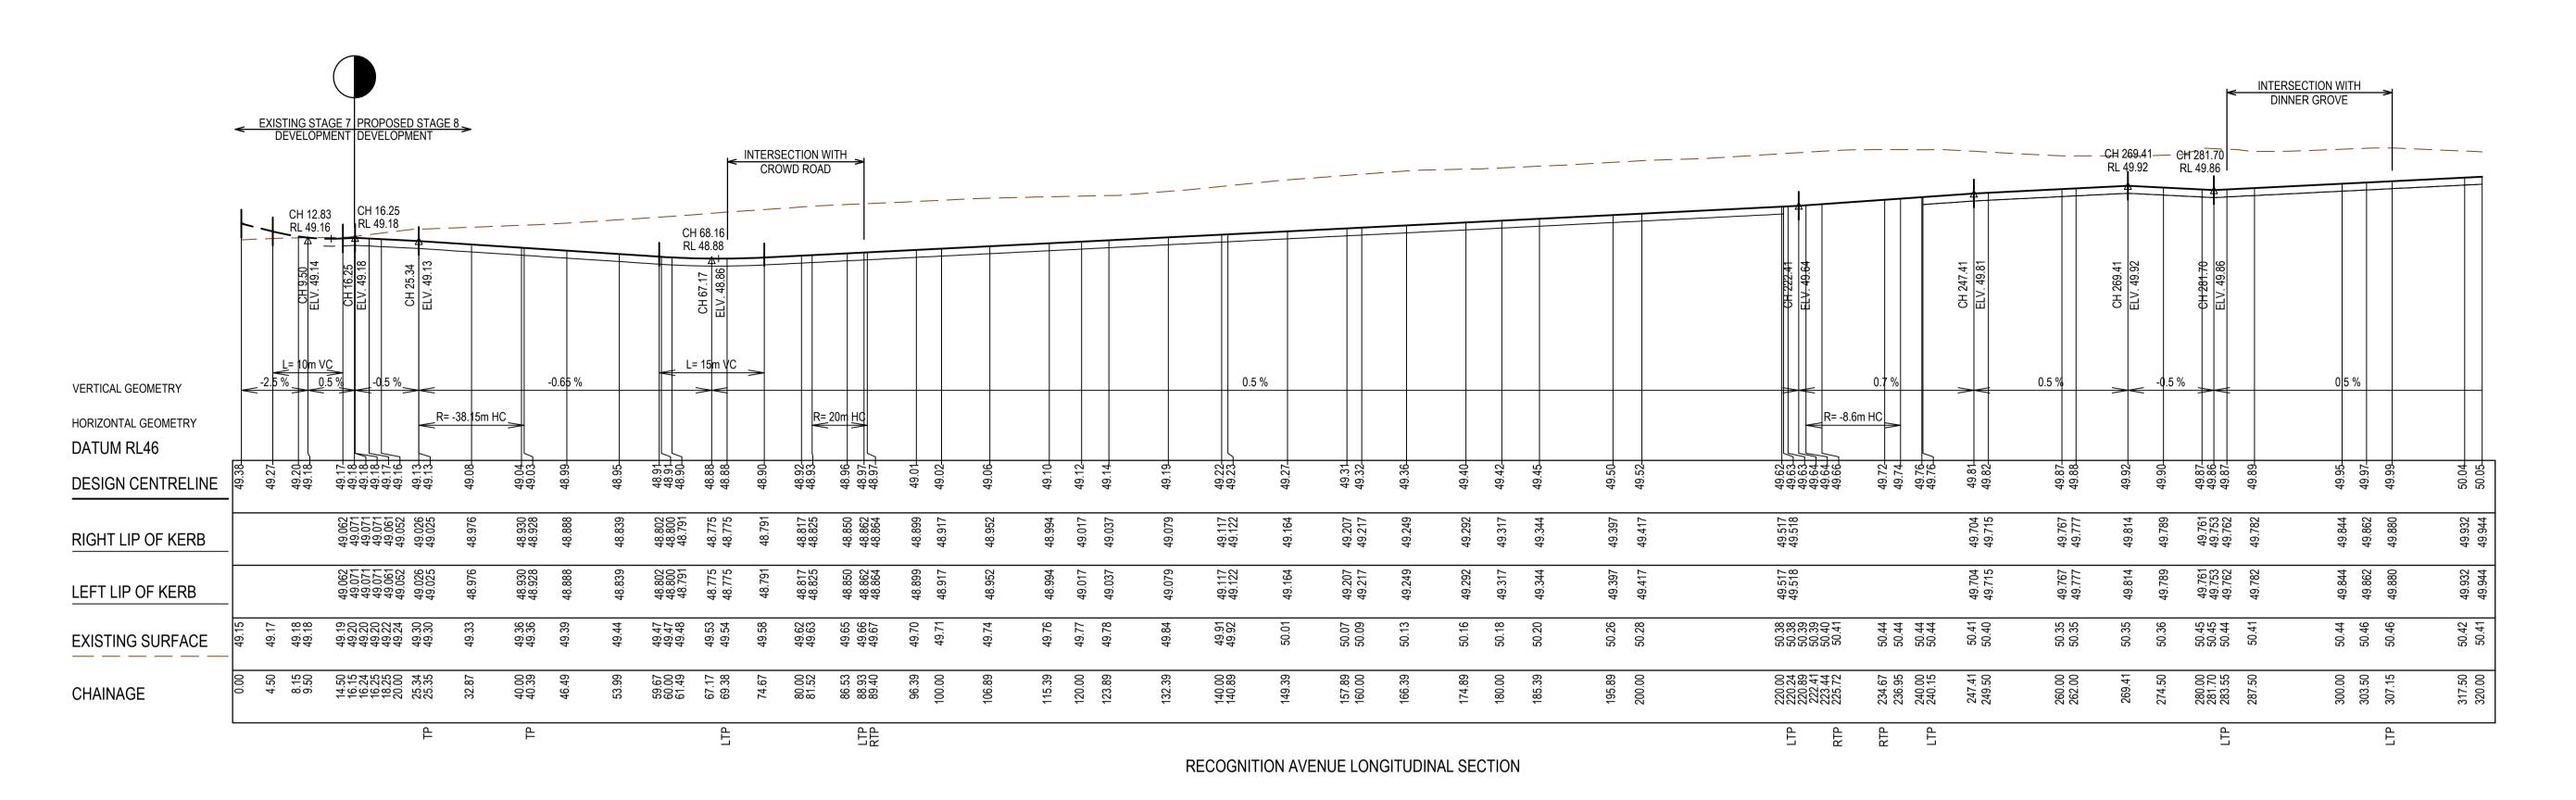

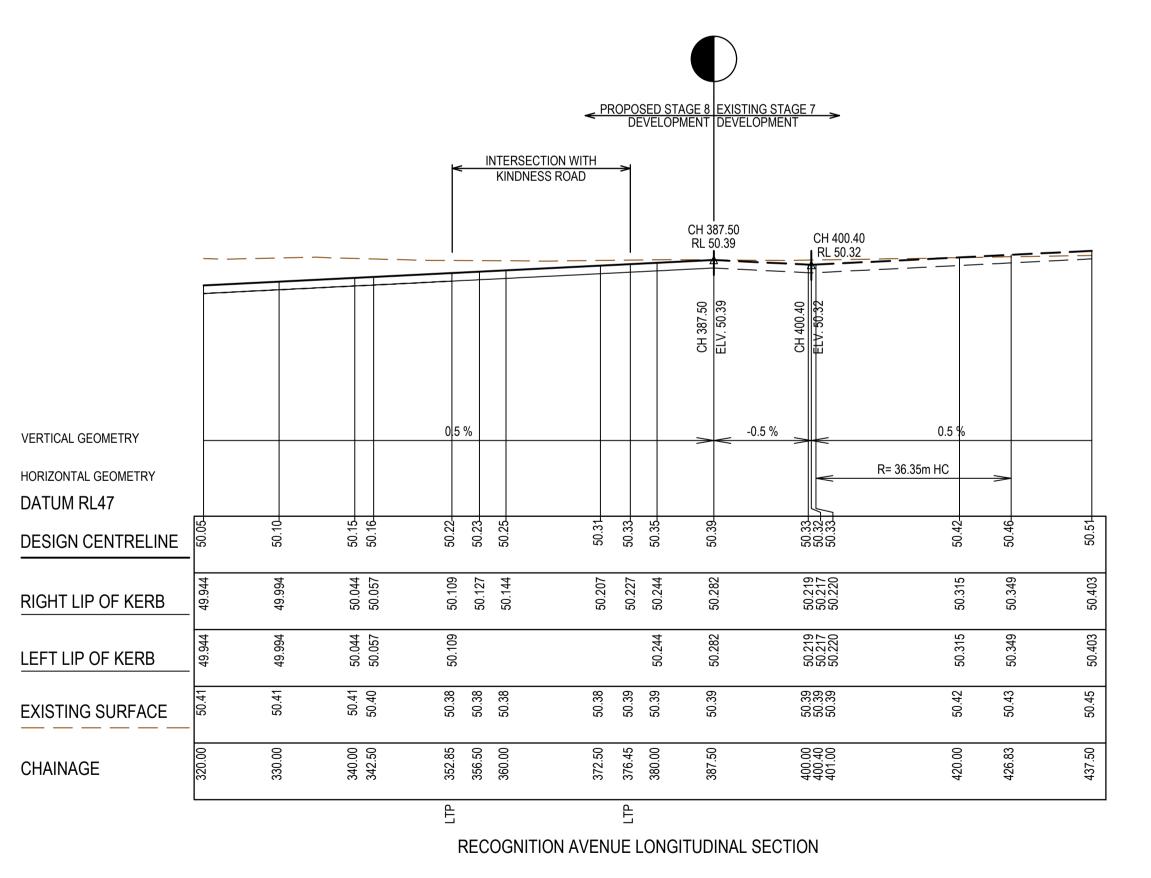

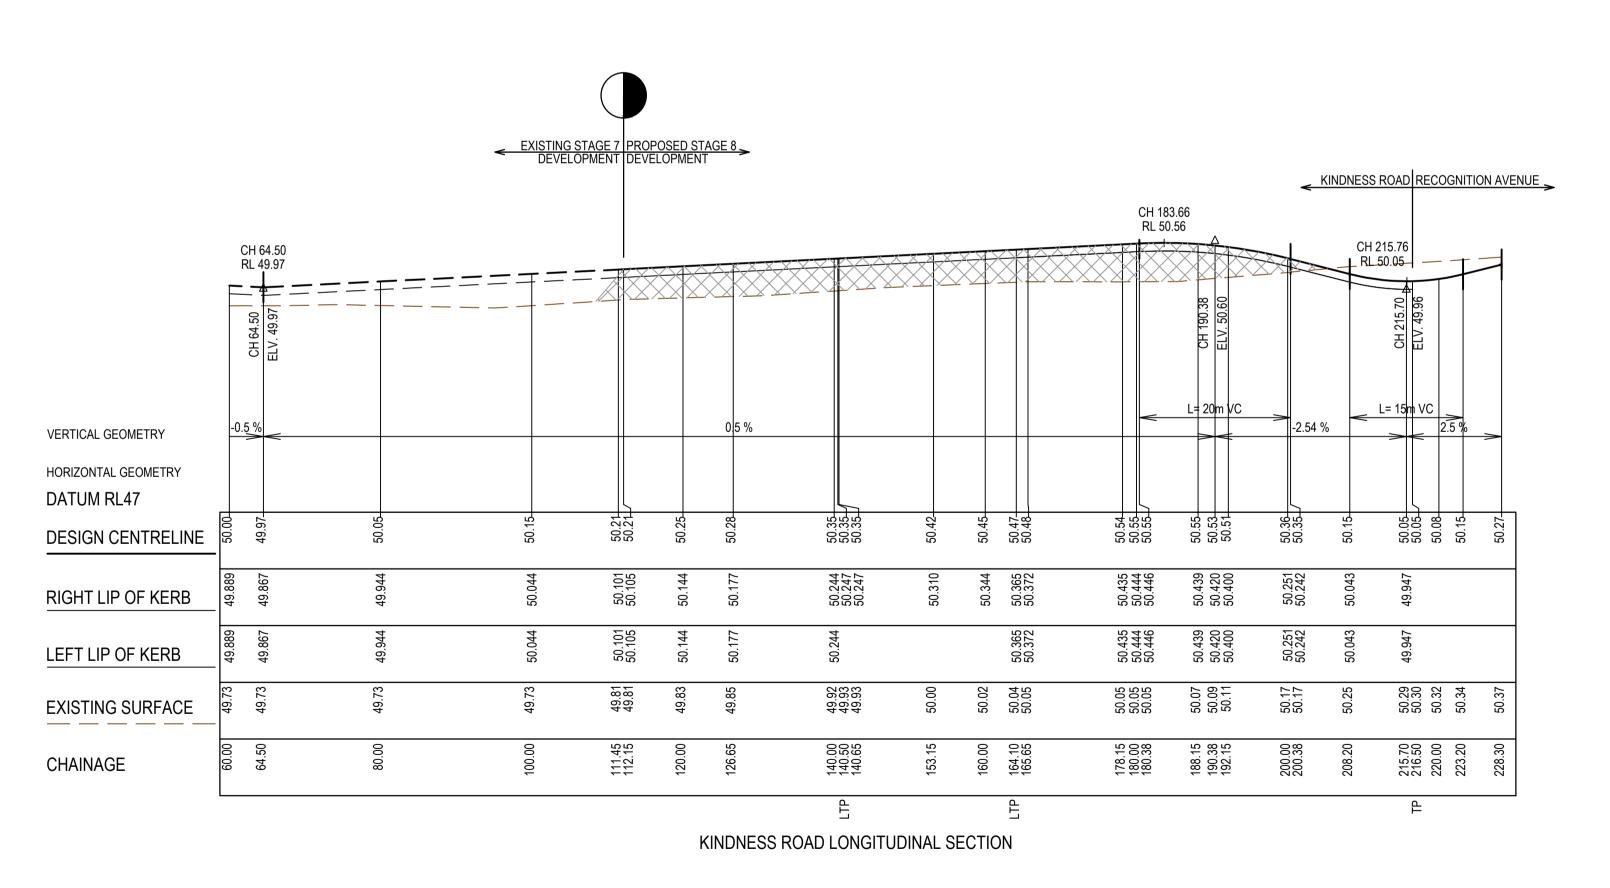

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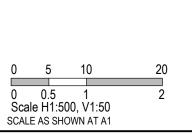





AS CONSTRUCTED










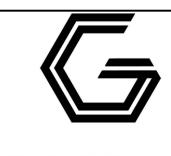


Marigold - Stage 8
Wyndham City Council
Road and Drainage Longitudinal Sections - 1


GROWLAND

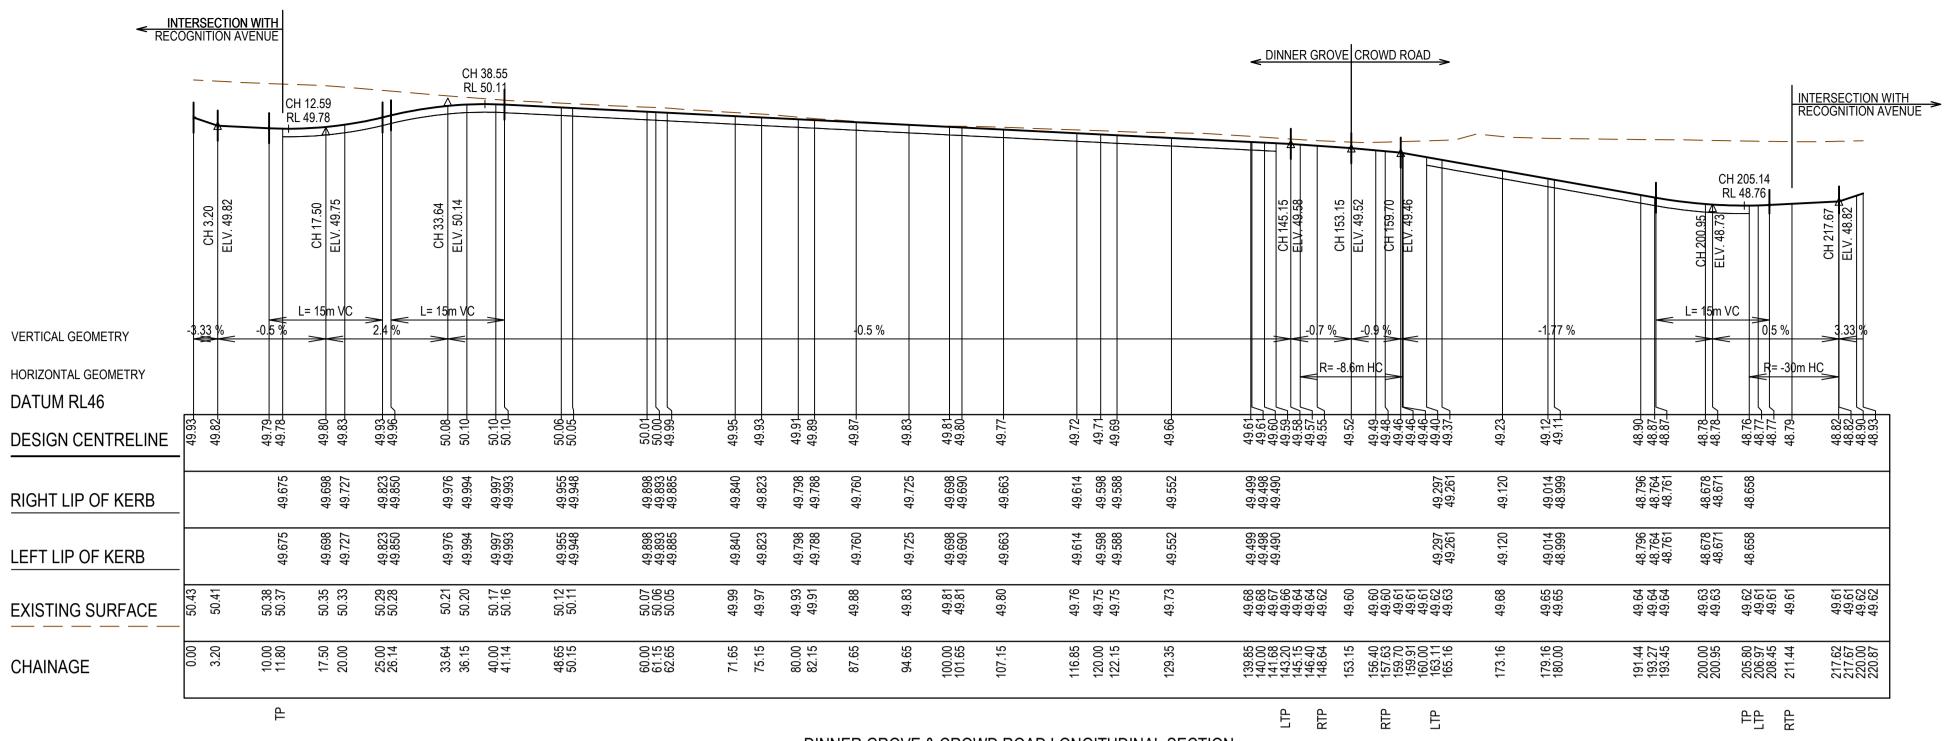

DINNER GROVE & CROWD ROAD LONGITUDINAL SECTION

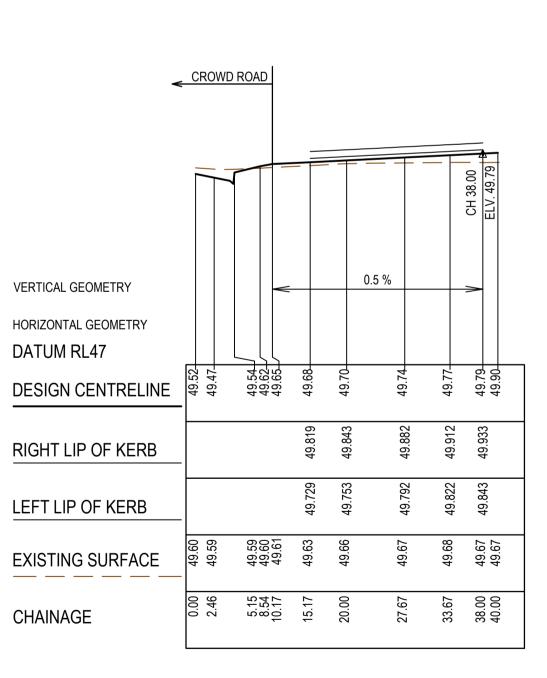

DRIVEWAY LONGITUDINAL SECTION

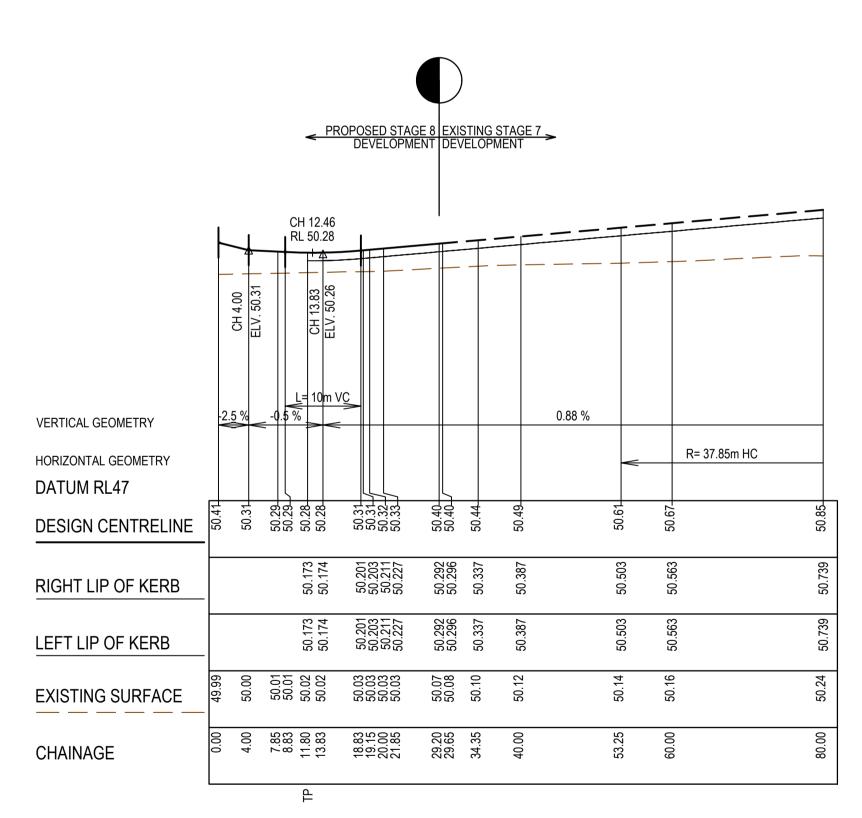

PRAISE ROAD LONGITUDINAL SECTION

AS CONSTRUCTED PLANS

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AS CONSTRUCTED





0 0.5 1 Scale H1:500, V1:50 SCALE AS SHOWN AT A1







Marigold - Stage 8
Wyndham City Council
Road and Drainage
Longitudinal Sections - 2

MELWAYS REF 359 F9 2360E-008-202

GROWLAND Ph 03 9514 1500

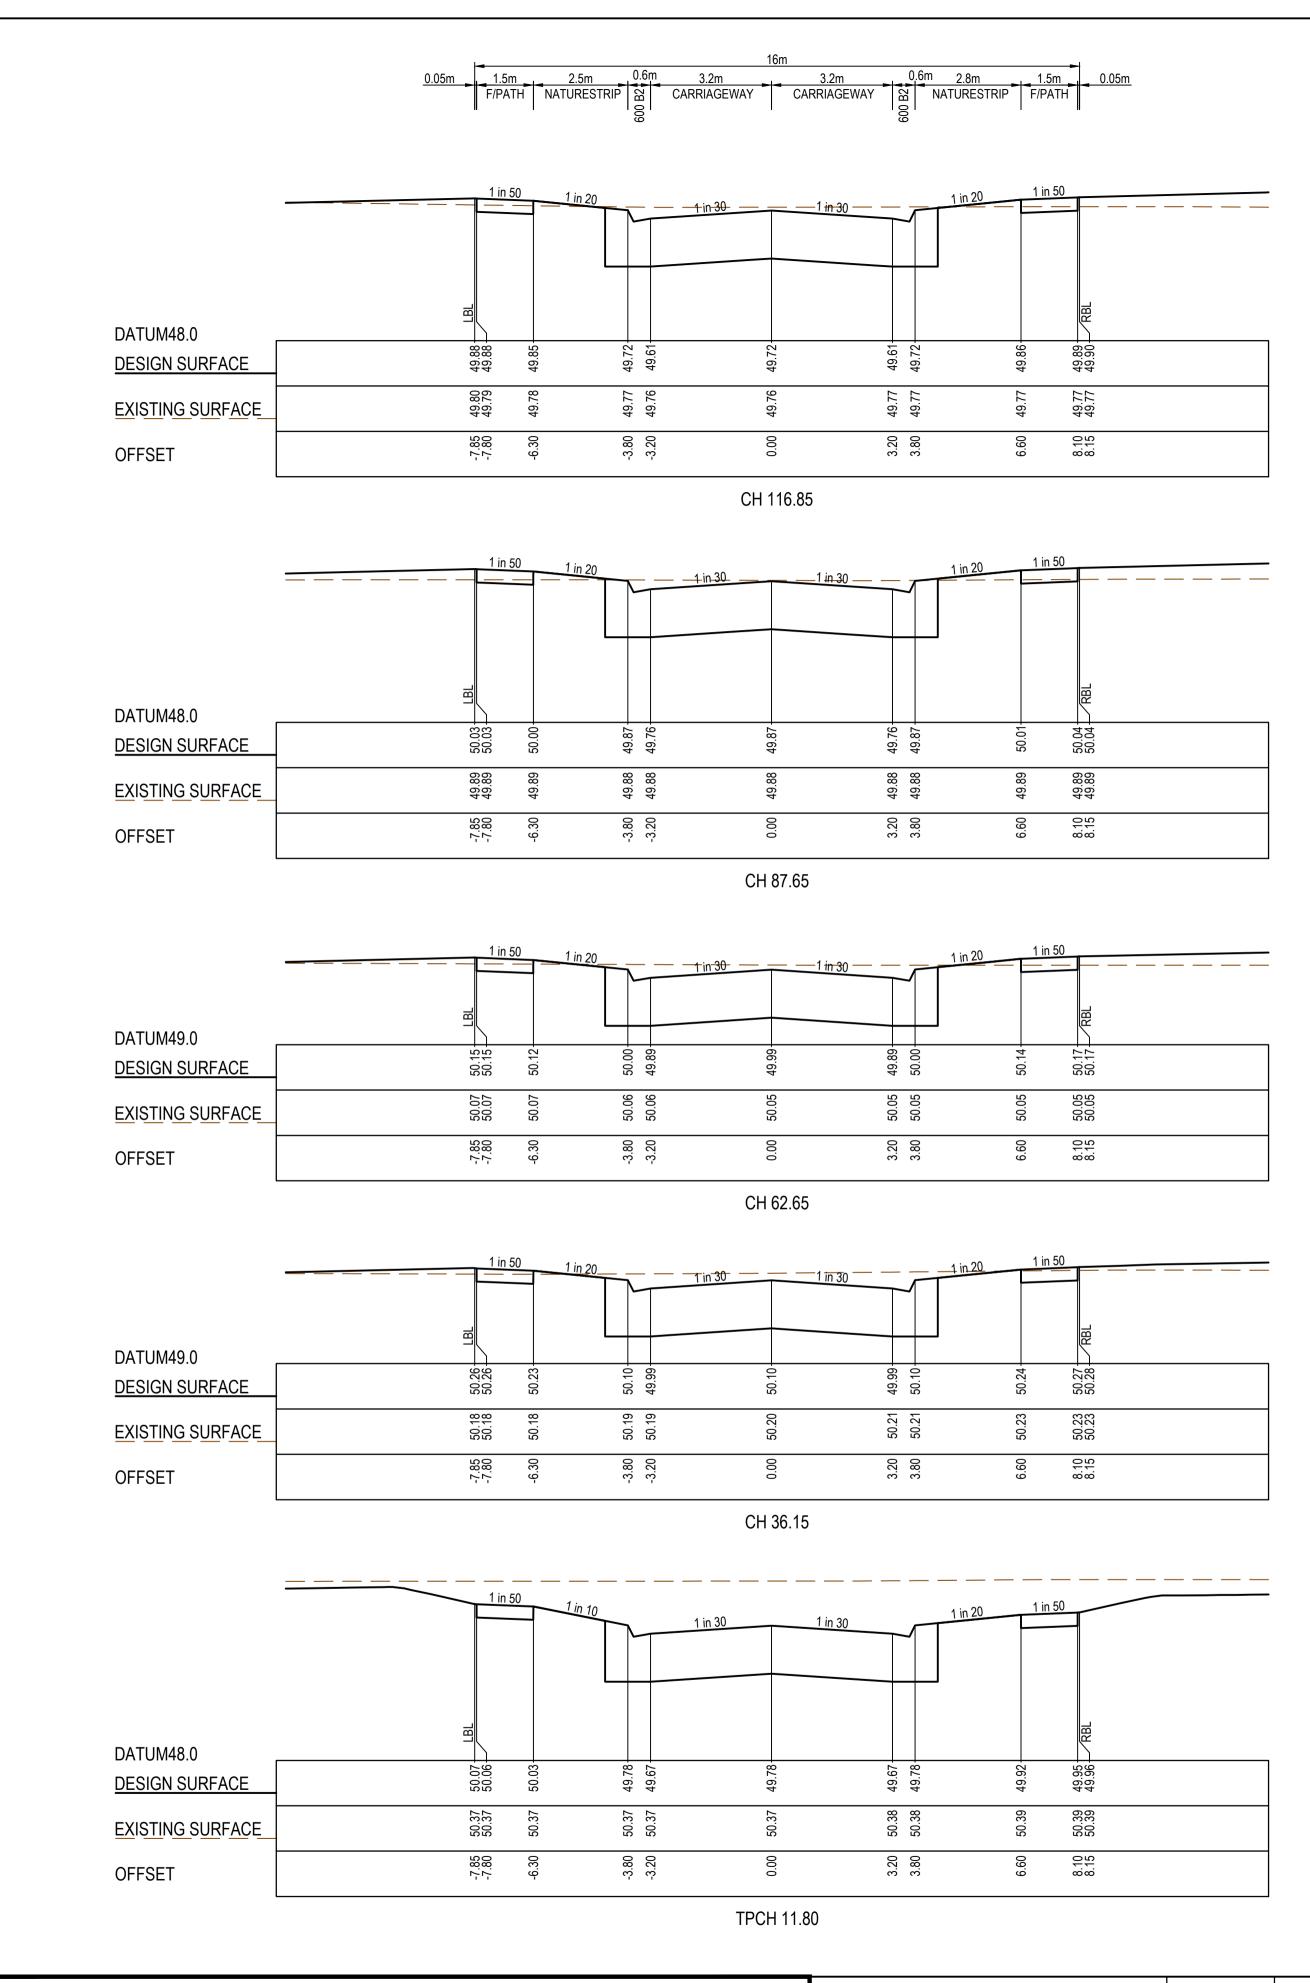


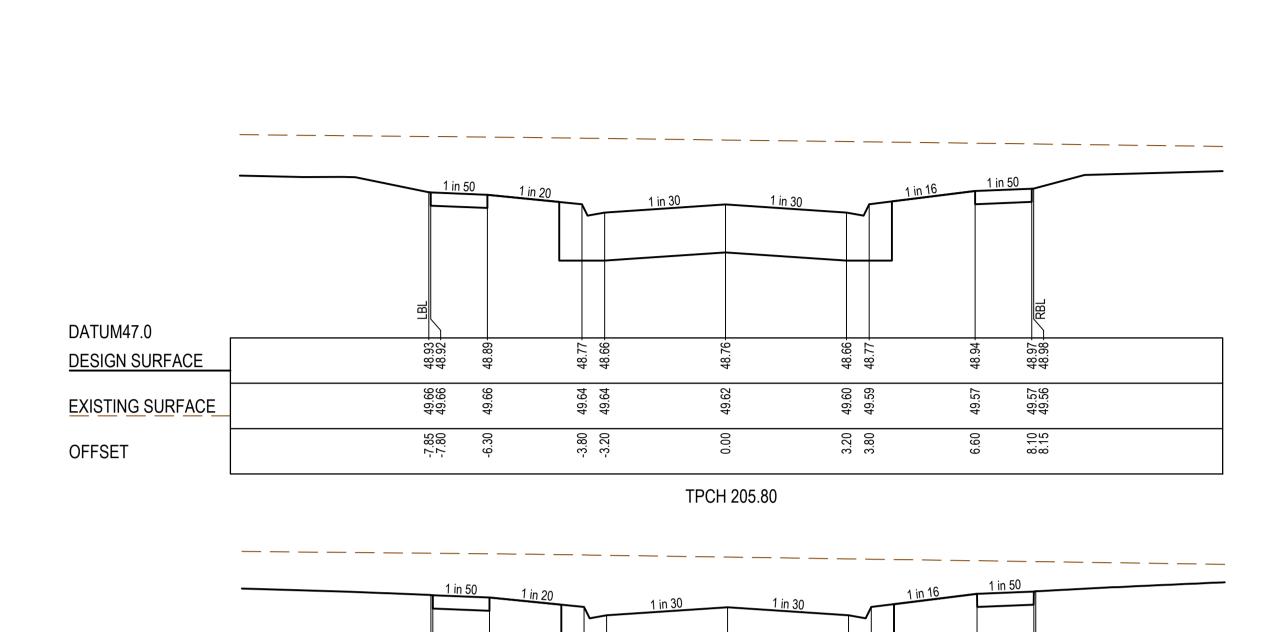


49.14 49.14

49.69 49.69

-7.85 -7.80 -6.30

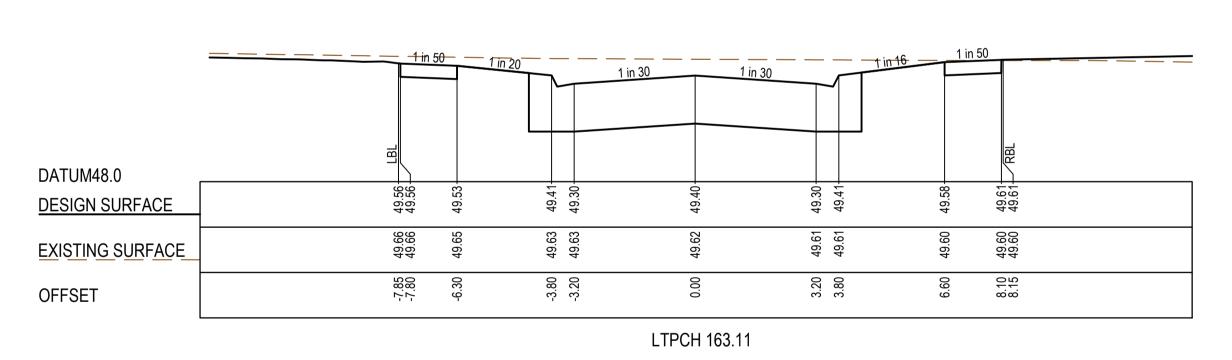

CH 187.16

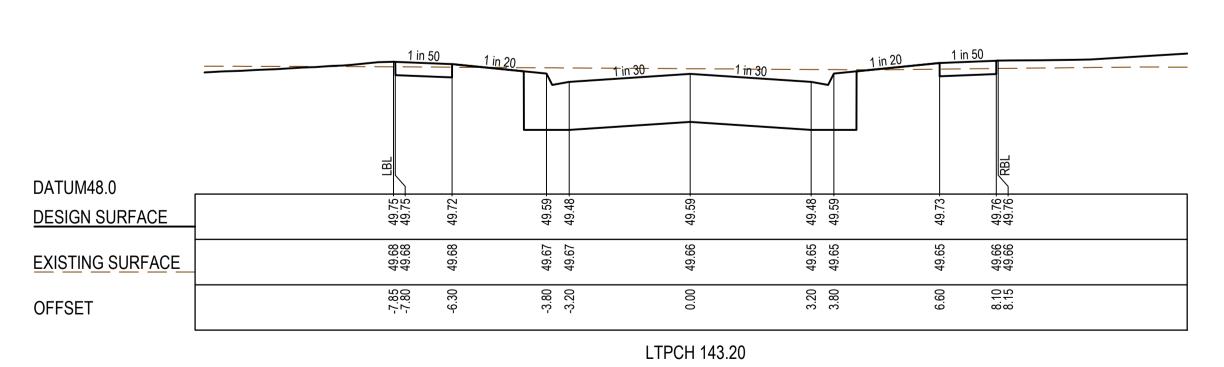

AS CONSTRUCTED PLANS

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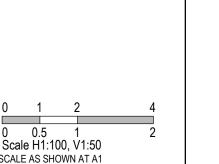




AS CONSTRUCTED









DATUM48.0

OFFSET

DESIGN SURFACE

EXISTING SURFACE



Marigold - Stage 8
Wyndham City Council
Road and Drainage
Cross Sections: Dinner Grove &
Crowd Road: Ch. 11.80 - Ch. 205.80

STRUCTURAL FILL REQUIRED UNDER PAVEMENT AND FOOTPATHS WHERE


CONSTRUCTED ABOVE EXISTING SURFACE

MELWAYS REF 2360E-008-251 SHEET No. 10 of 19


49.58 49.58


8.10 8.15


3.20

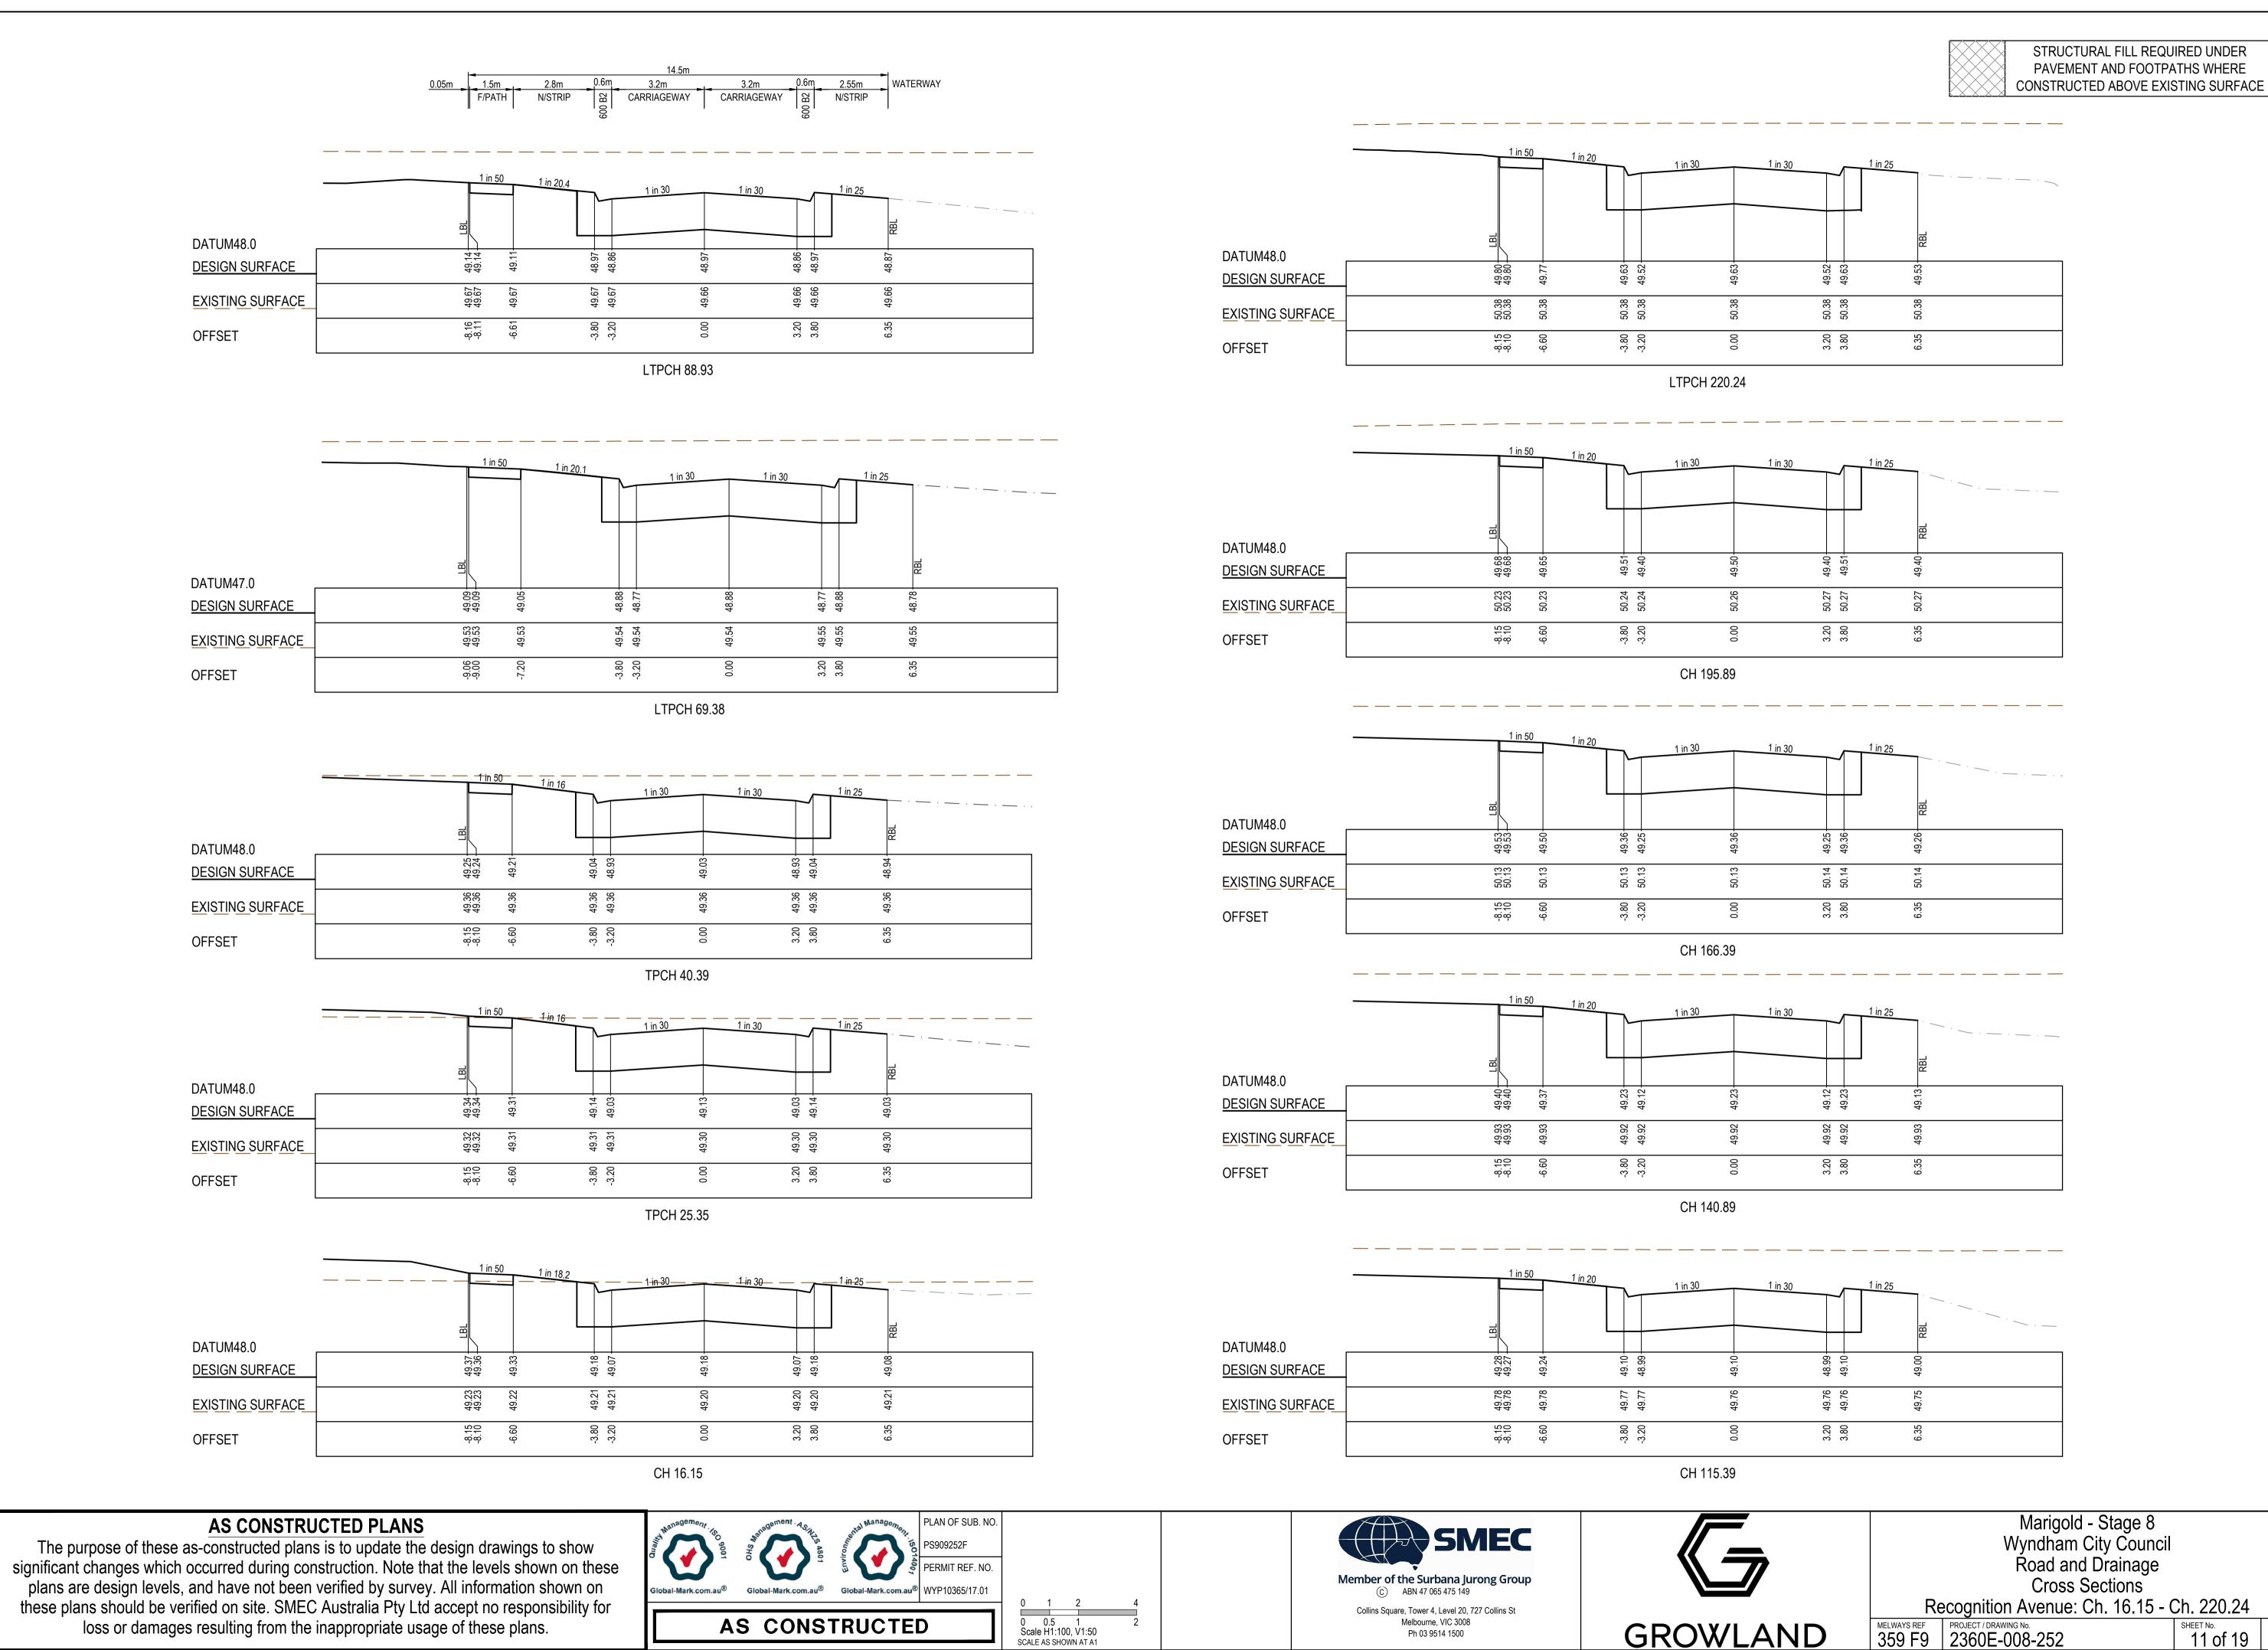



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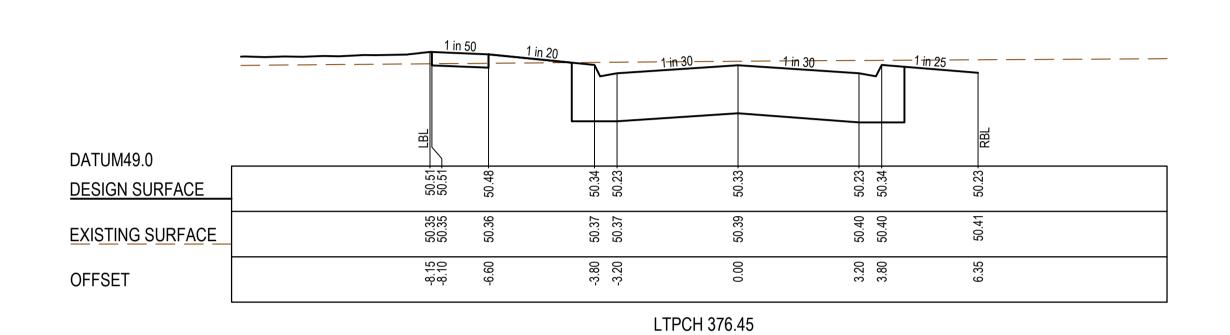


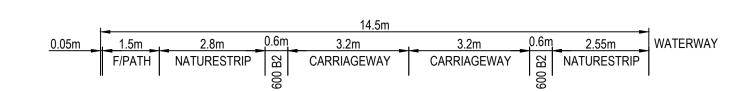


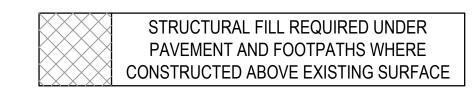


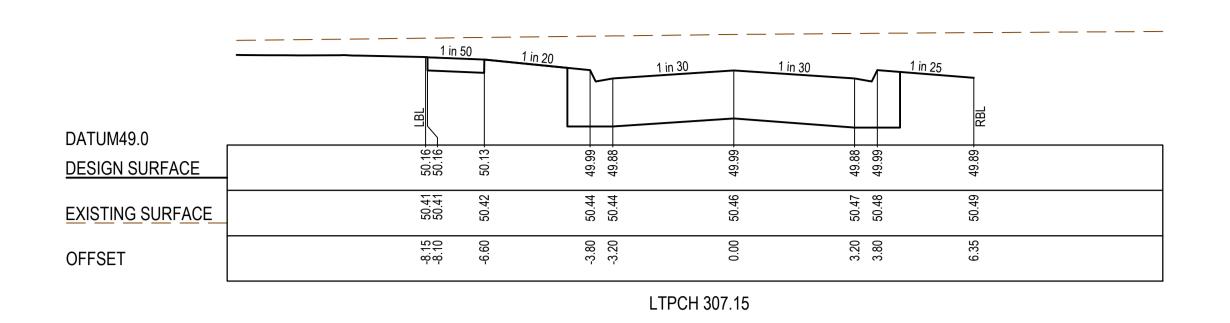


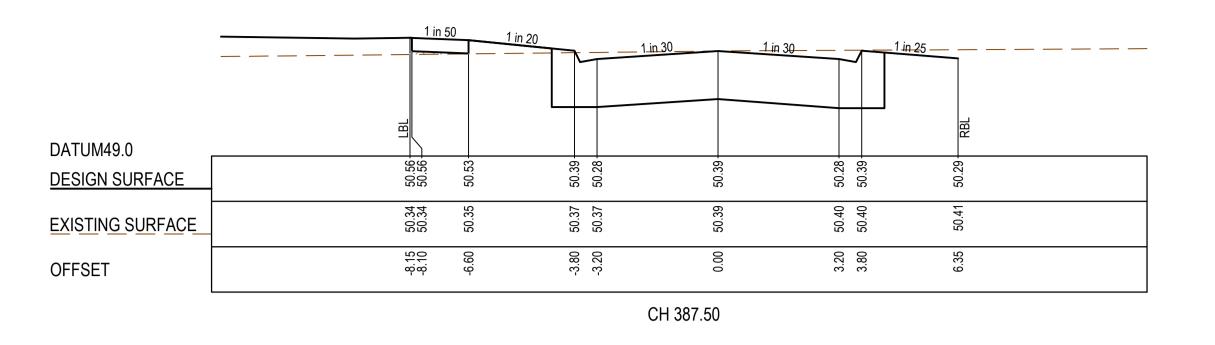

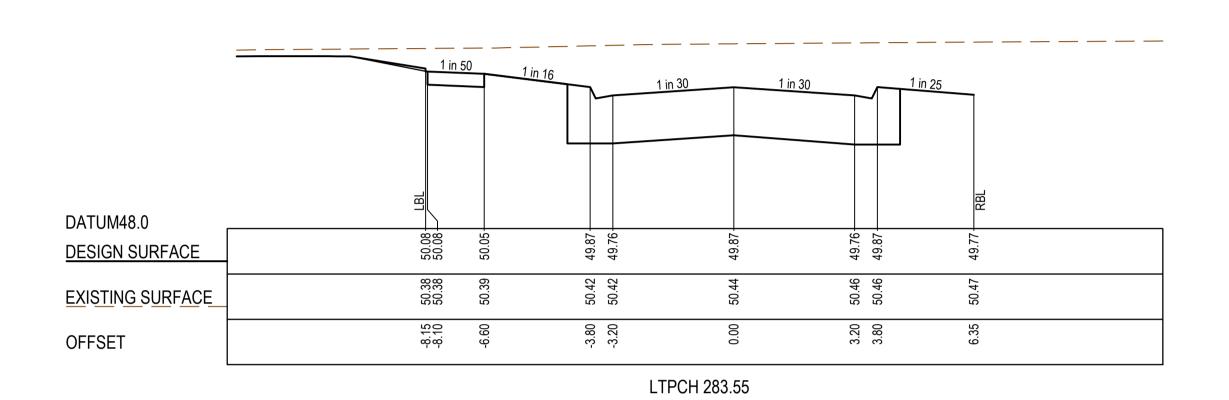

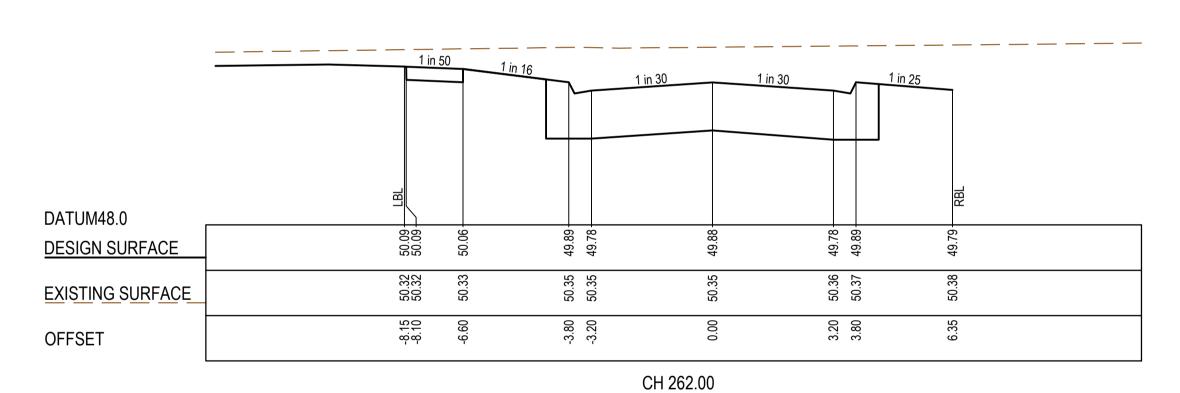

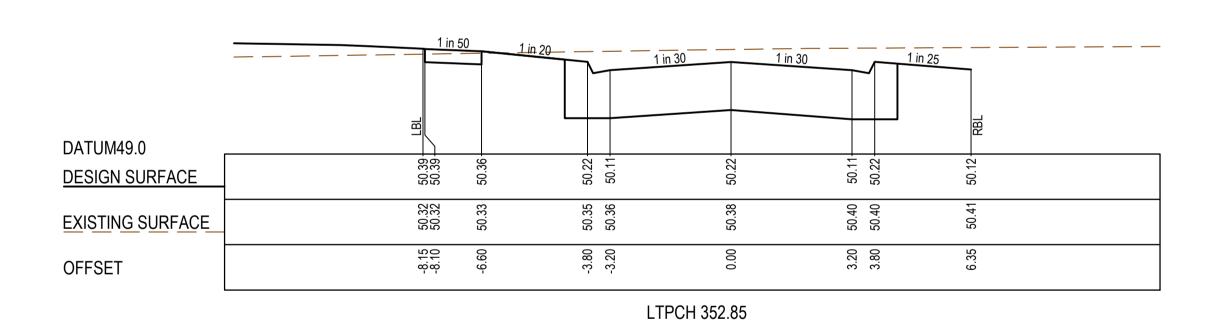

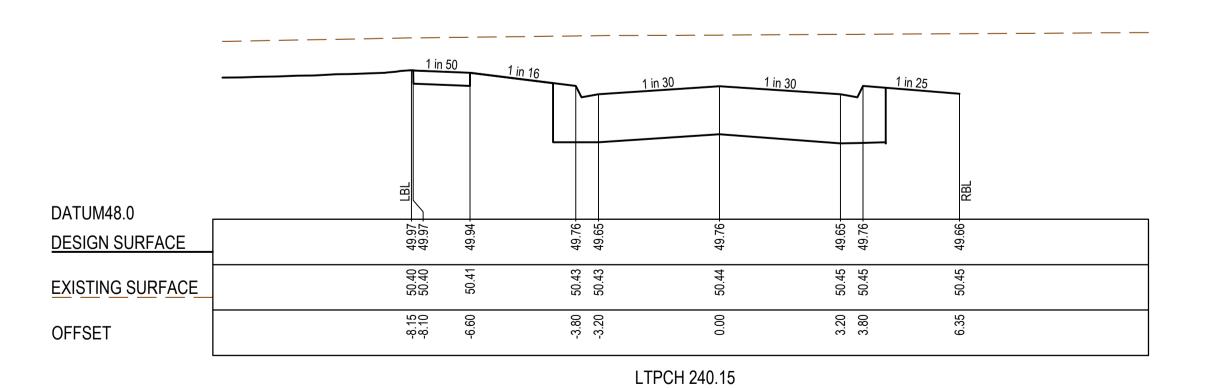

DATUM49.0		n 501	in 20 1 in	30 1 i	n 30 1 in 25	RBL	- — — —
DESIGN SURFACE	50.28	50.24	50.10+	50.10	49.99	50.00	
<u>DEGICIT CONTROL</u>		2			4 rc	Ω	
EXISTING SURFACE	50.36 50.36	50.37	50.39	50.41	50.44	50.45	
OFFSET	-8.15 -8.10	-6.60	-3.20	0.00	3.20	6.35	
	L		CI	H 330.00			


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AS CONSTRUCTED








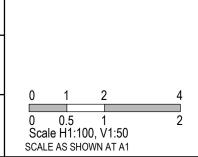

Marigold - Stage 8
Wyndham City Council
Road and Drainage
Cross Sections

Recognition Avenue: Ch. 240.15 - Ch. 387.50 MELWAYS REF PROJECT / DRAWING No. 2360E-008-253

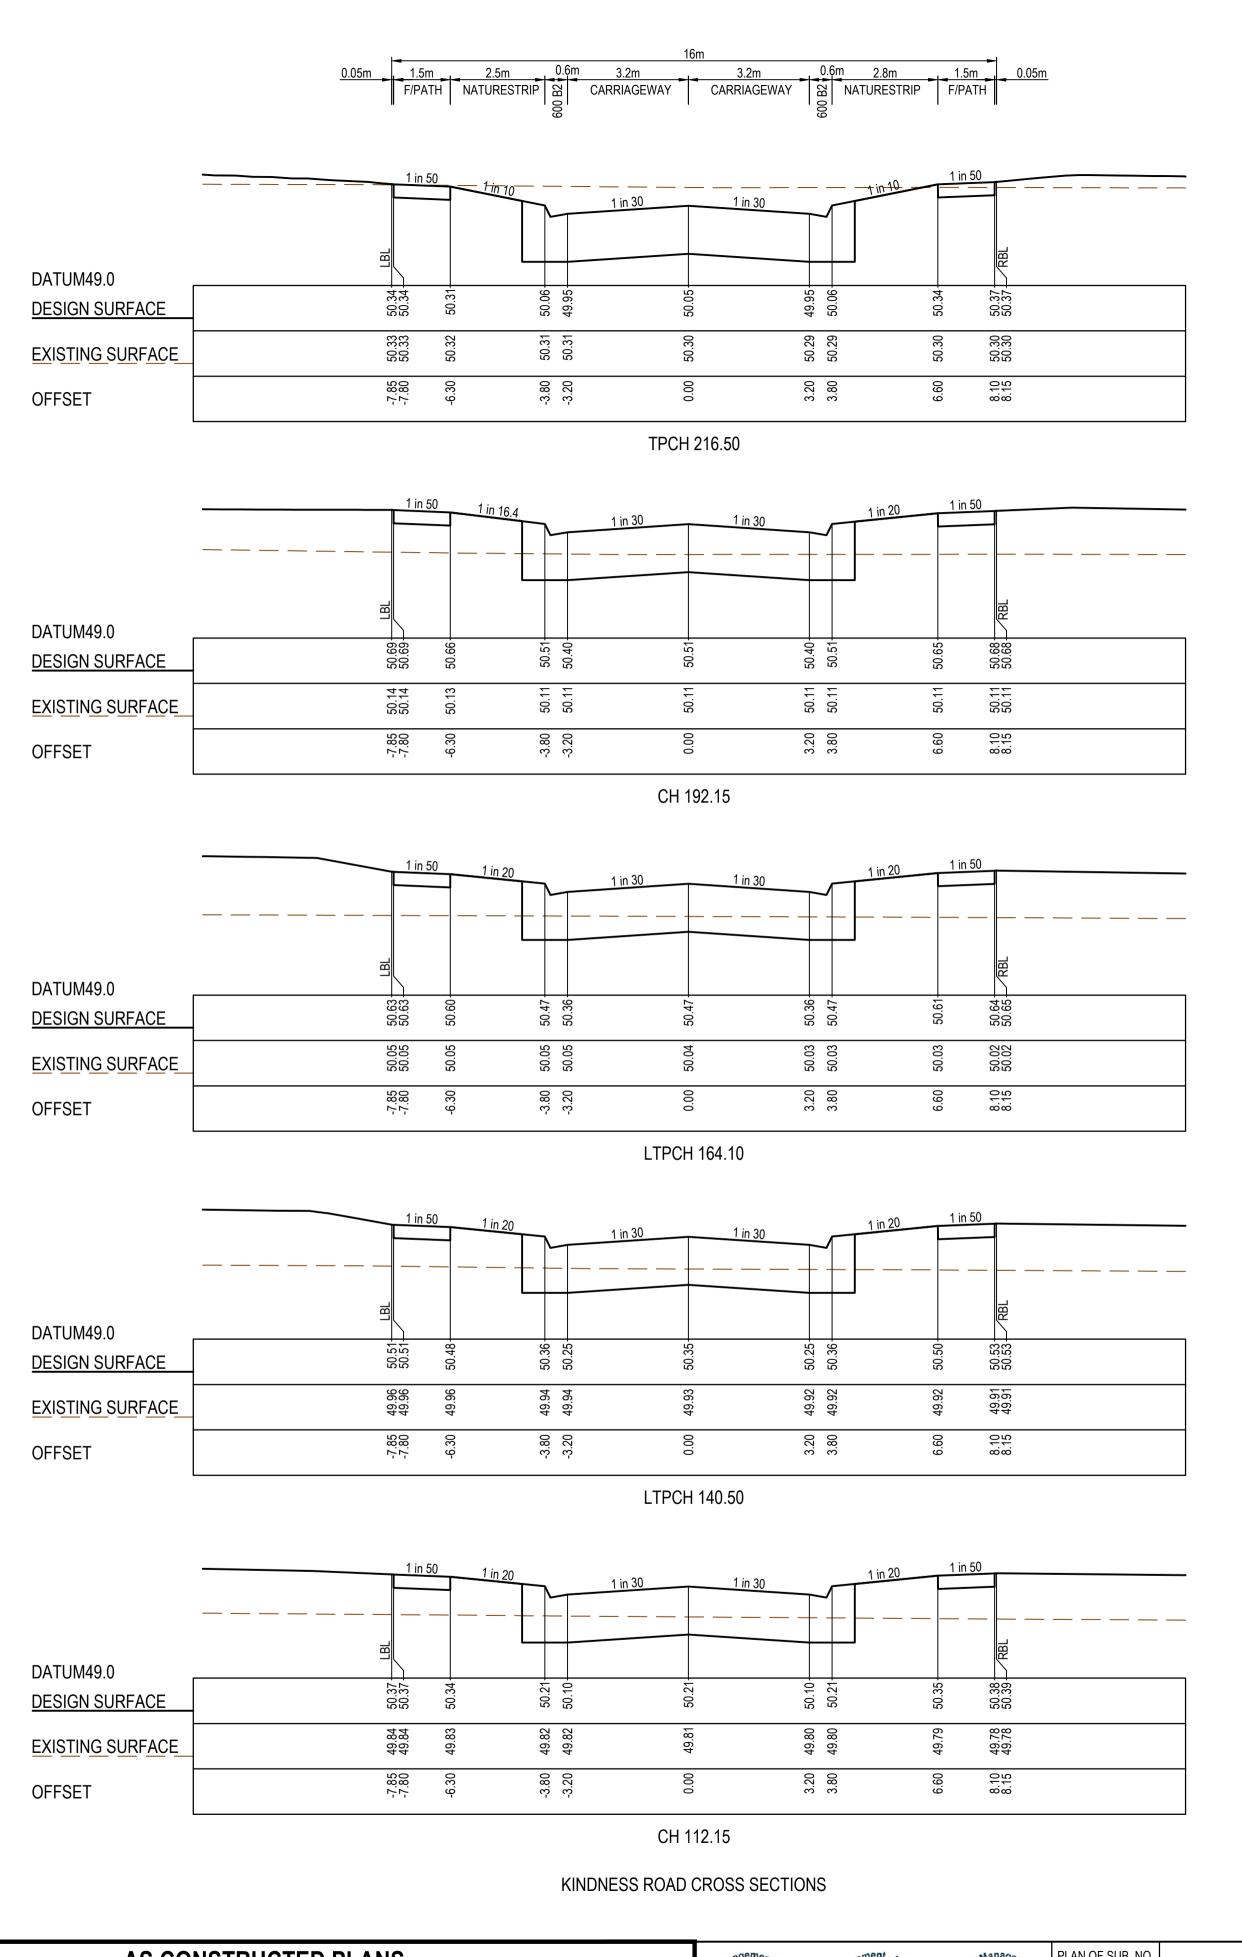

STRUCTURAL FILL REQUIRED UNDER
PAVEMENT AND FOOTPATHS WHERE
CONSTRUCTED ABOVE EXISTING SURFACE

0.05m 1.5m 2.45m 2m 2m 2.1m 1.9m F/PATH NATURESTRIP EXT. DWAY EXT. DWAY P/BAY N/STRIP


		1 in 50)	1 in 33	1 in 40		1 in 30		in 15	 _
DATUM49.0	į	IBL							RBL	
DESIGN SURFACE		49.90 49.90	49.87	40.70		49.74	49.81	49.88-	50.01-	
EXISTING SURFACE		49.66 49.66	49.67	79 67	0.00	49.67	49.67	49.67	49.67	
OFFSET		-6.00 -5.95	-4.45	000	00:3	00.00	2.00	4.10	6.00	


CH 27.67

		1 in 50	1 in 33	1 in 40	1	in 30	1 in 15	
DATUM49.0	LB.							RBL
DESIGN SURFACE	5	49.04 49.83 49.83	49.80	49.73	49.68	49.75	49.82	49.94
EXISTING SURFACE	6	49.62 49.62	49.63	49.63	49.63	49.64	49.64	49.65
OFFSET	C C		4.45	-2.00	0.00	2.00	4.10	0.00

EXTENDED DRIVEWAY CROSS SECTIONS

CH 15.17

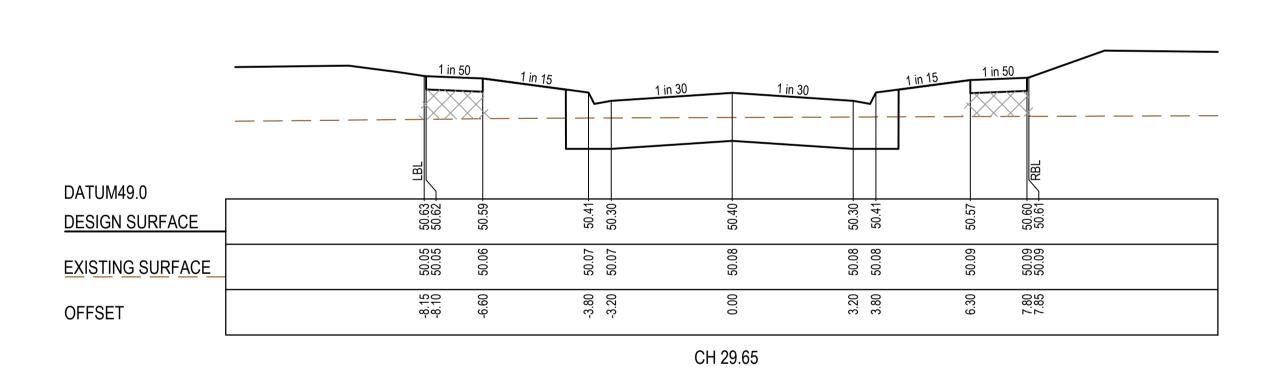

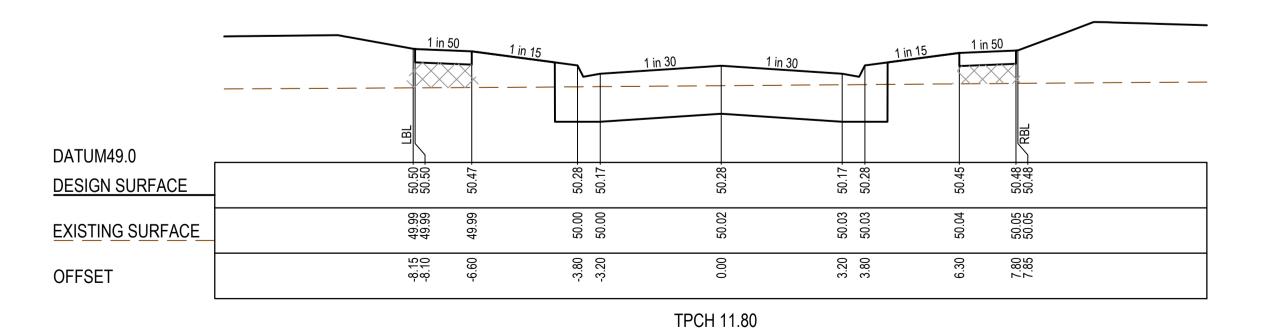


PRAISE ROAD CROSS SECTIONS

AS CONSTRUCTED PLANS -constructed plans is to update the design drawings to show

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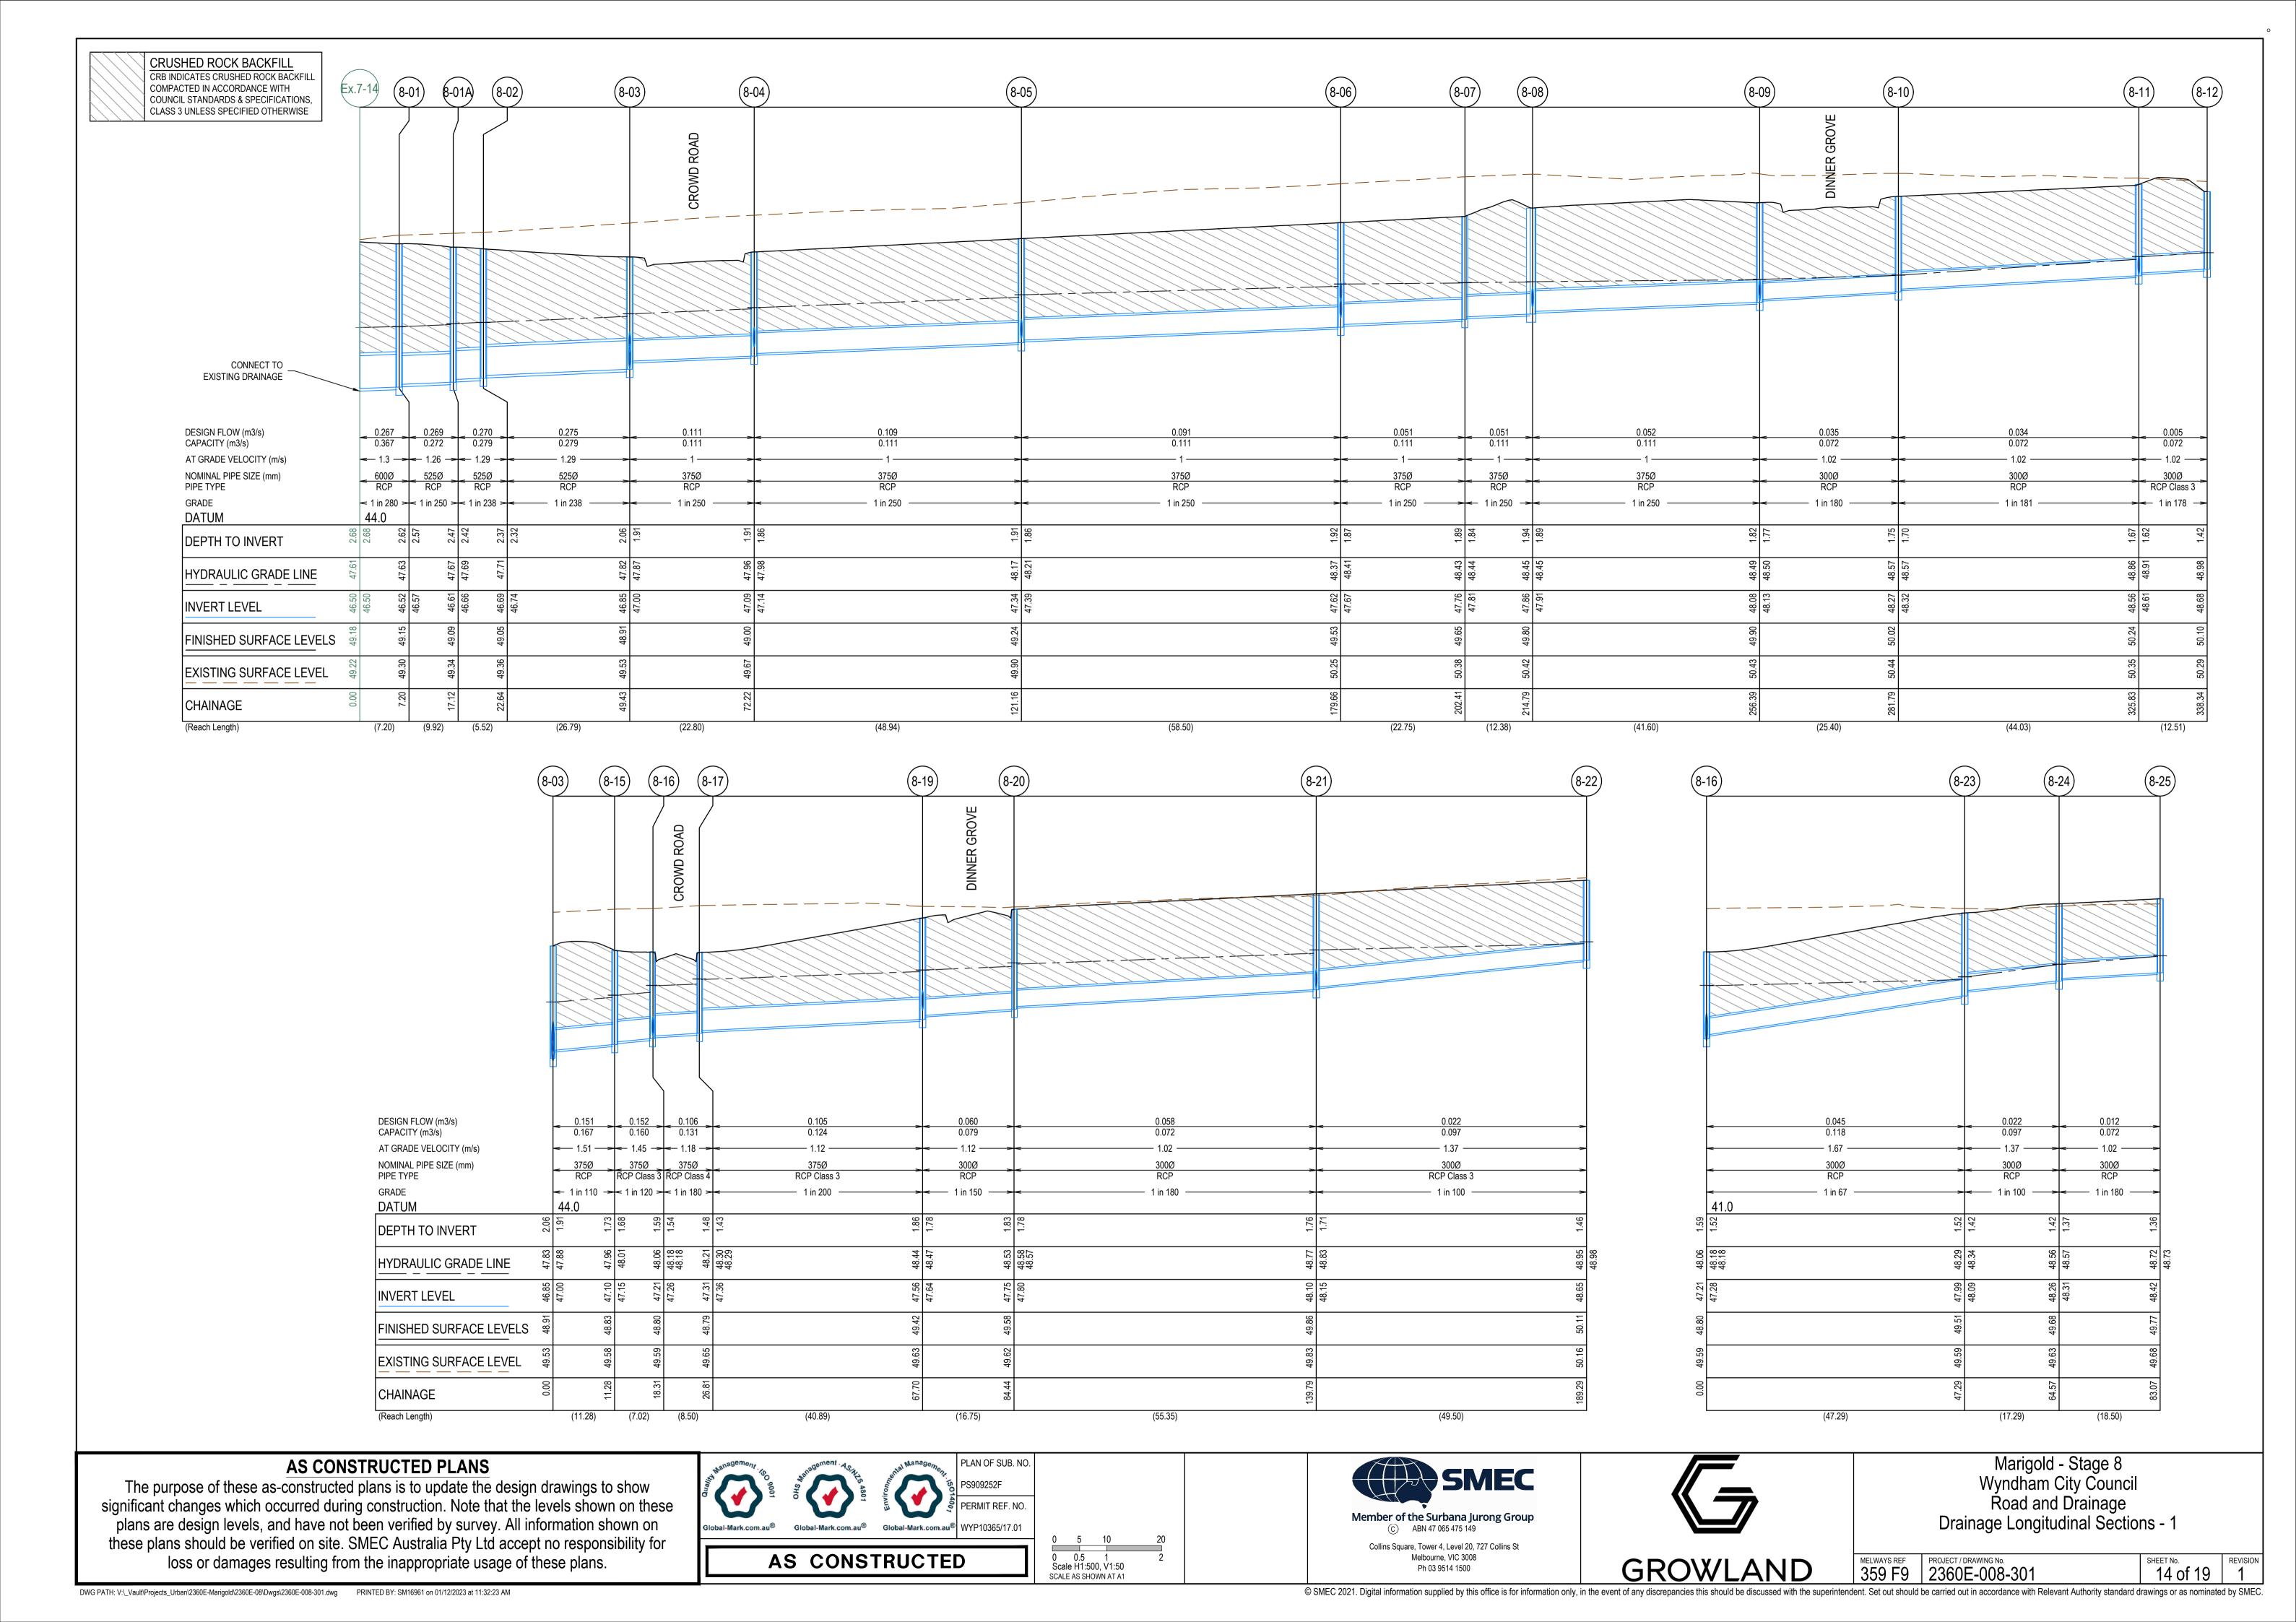





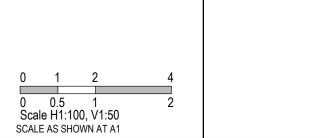

Marigold - Stage 8
Wyndham City Council
Road and Drainage
Cross Sections: Kindness Rd Ch.112.15 - Ch.216.50
& Praise Road Ch. 11.80 - Ch. 29.20

MELWAYS REF PROJECT / DRAWING No. SHEET No. RE 359 F9 2360E-008-254 13 of 19



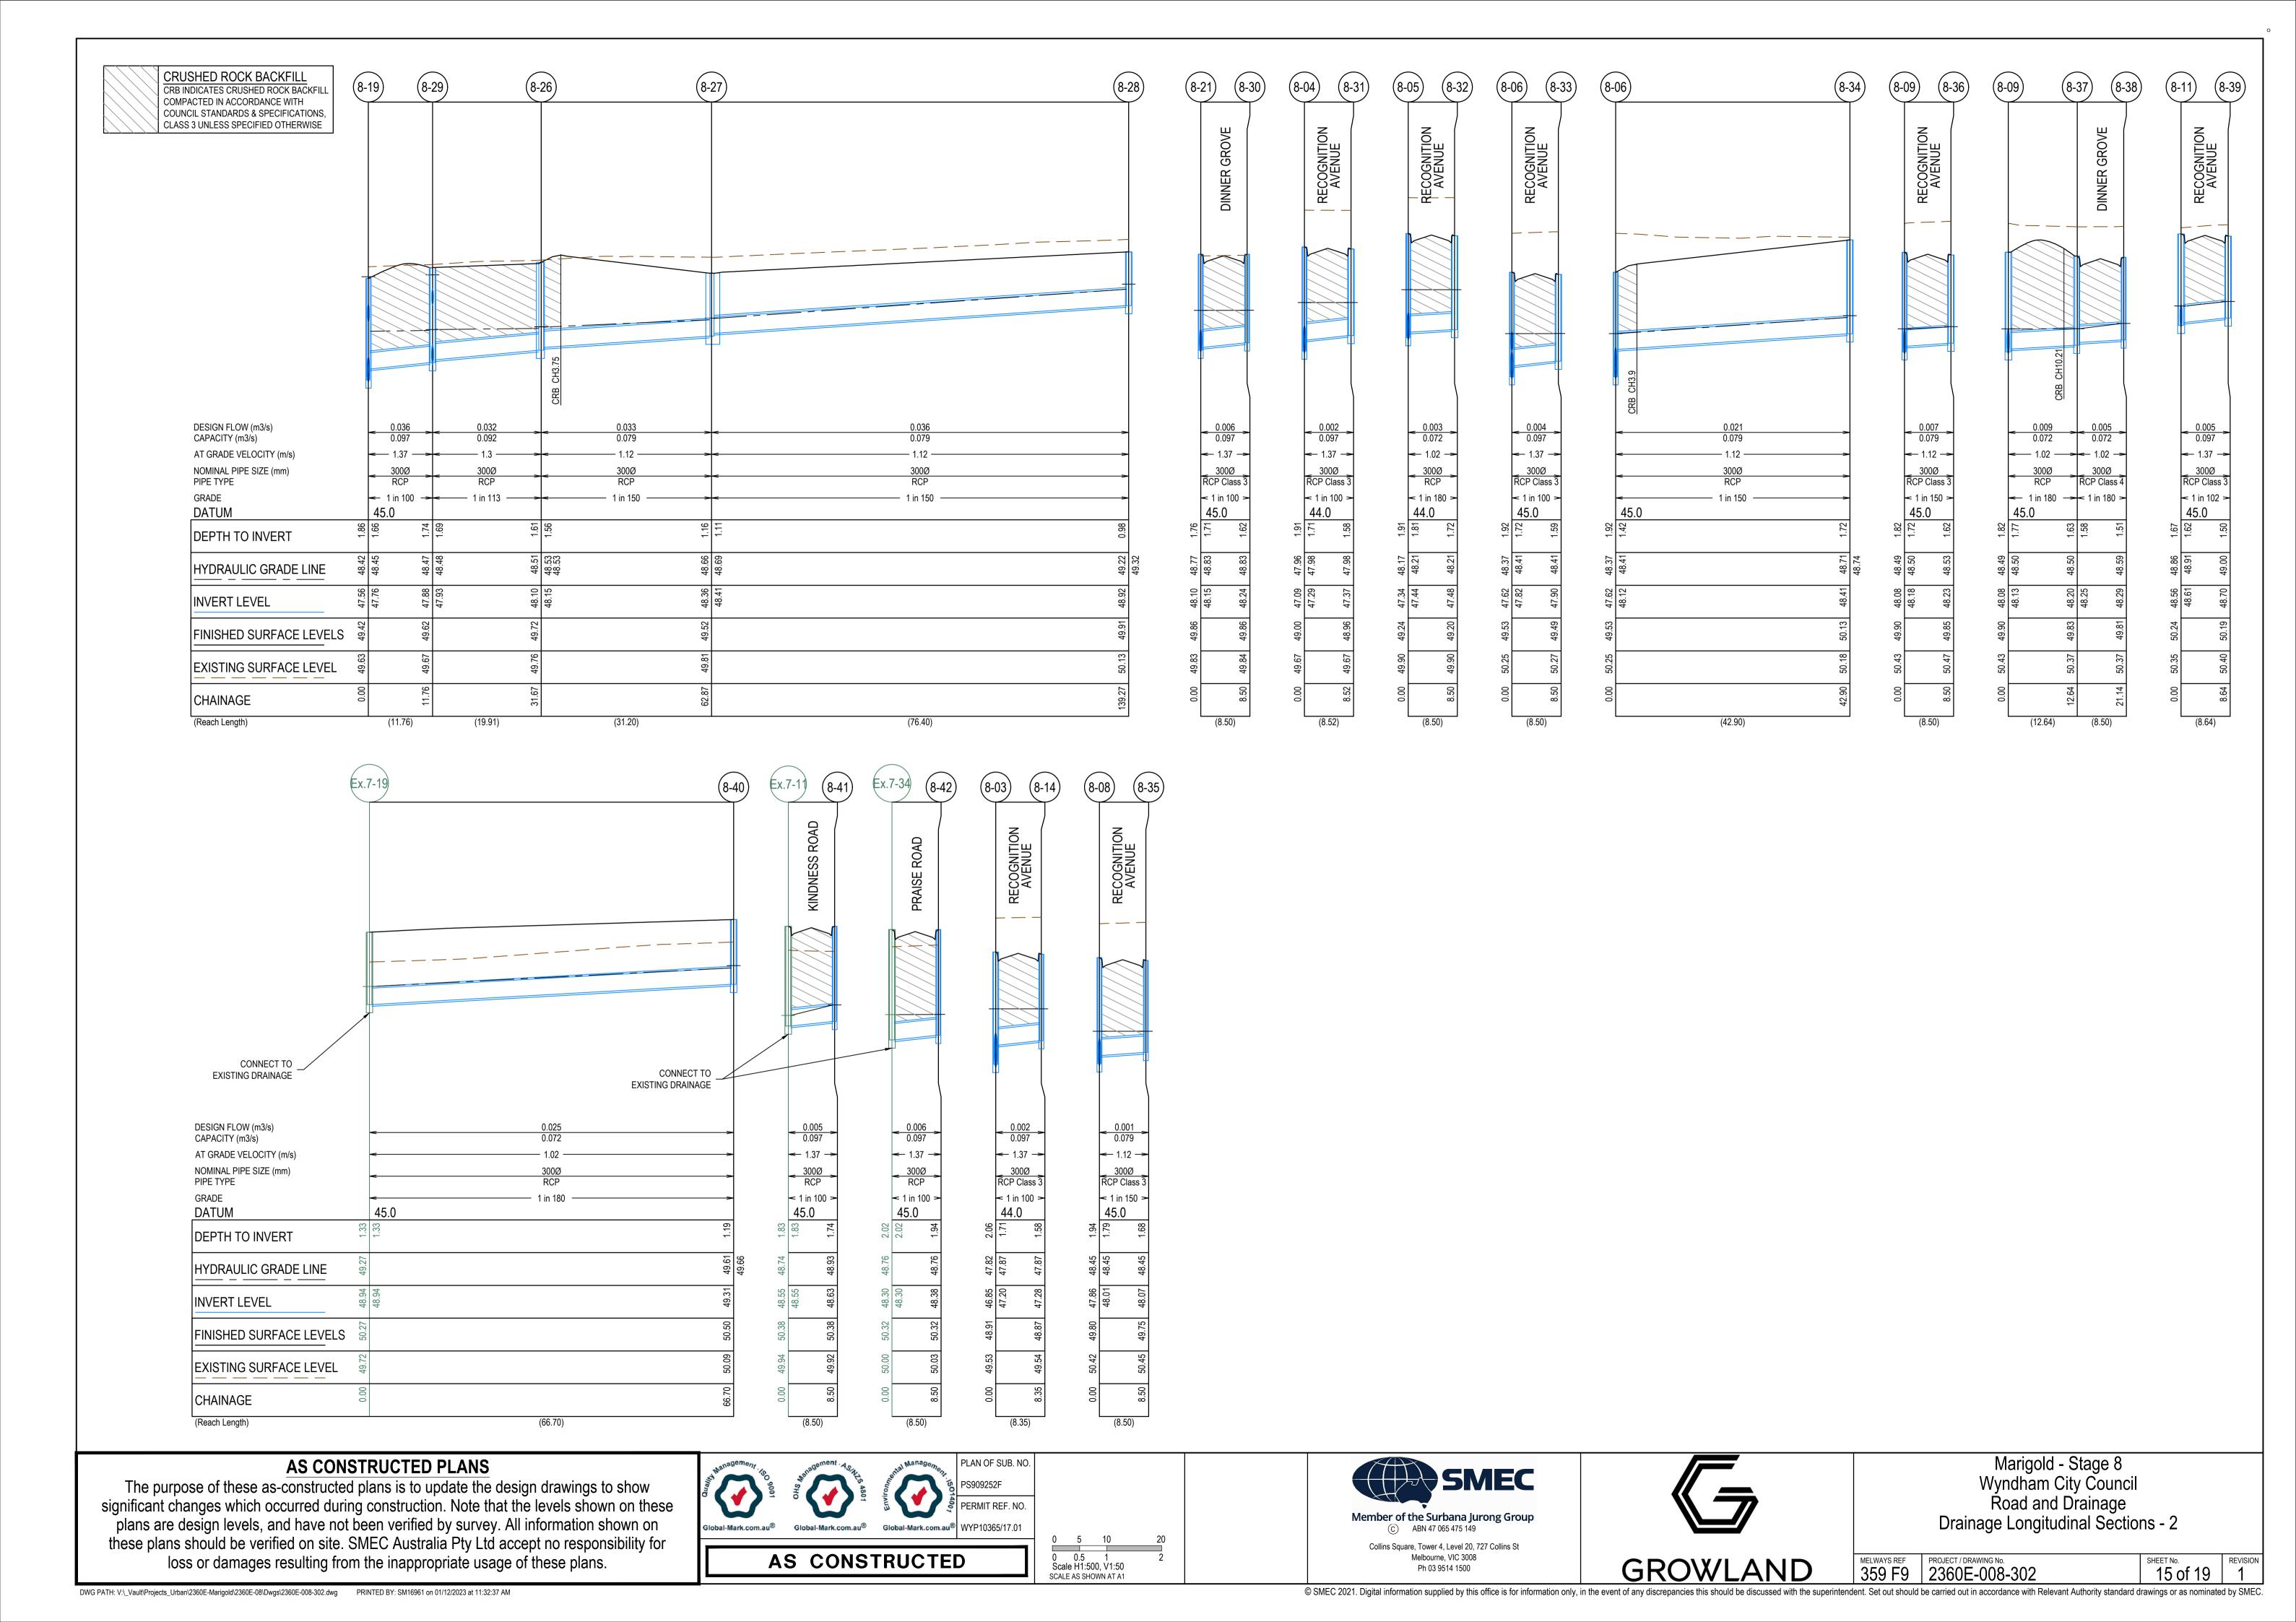

	PIT SCHEDULE												
		INTER	ΡΝΙΔΙ	_ INLET OUTLET									
PIT NUMBER	TYPE					OUTLET		F.S.L.	DEPTH	STANDARD DRAWING	REMARKS		
		WIDTH (mm)	LENGTH (mm)	DIAMETER (mm)	INV R.L.	DIAMETER (mm)	INV R.L. (m)			DIVAVIINO			
Ex.07-14	ENDPIPE	(11111)	(11111)	600	46.497	600	46.497	49.18	2.683	EDCM 601	CONNECT TO EXISTING PIPE		
08-01	JUNCTION PIT	900	900	525	46.573	600	46.523	49.146	2.623	EDCM 601	PIT TO BE HAUNCHED. 600x900 RISER BEHIND KERB. CHAMBER UNDER KERB. REFER TO SHEET 421- GENERAL DETAILS FOR PIT DETAILS		
08-01A	JUNCTION PIT	900	900	525	46.662	525	46.612	49.086	2.474	EDCM 601	PIT TO BE HAUNCHED. 600x900 RISER BEHIND KERB. CHAMBER UNDER KERB. REFER TO SHEET 421- GENERAL DETAILS FOR PIT DETAILS		
08-02	JUNCTION PIT	750	900	525	46.736	525	46.686	49.054	2.368	EDCM 601	PIT TO BE HAUNCHED. 600x900 RISER BEHIND KERB. CHAMBER UNDER KERB. REFER TO SHEET 421- GENERAL DETAILS FOR PIT DETAILS		
08-03	DOUBLE SIDE ENTRY PIT	750	900	375	46.998	525	46.848	48.907	2.059	EDCM 601	PIT TO BE HAUNCHED. 600x900 RISER BEHIND KERB. CHAMBER UNDER KERB. REFER TO SHEET 421- GENERAL DETAILS FOR PIT DETAILS		
				300	47.198								
				375	46.898								
08-04	SIDE ENTRY PIT	600	900	375	47.139	375	47.089	48.997	1.908	EDCM 601			
				300	47.289								
08-05	SIDE ENTRY PIT	600	900	375	47.385	375	47.335	49.242	1.907	EDCM 601			
				300	47.435								
08-06	SIDE ENTRY PIT	600	900	375	47.669	375	47.619	49.534	1.915	EDCM 601			
				300	47.819								
00.07	U INICTIONI DIT	500	000	300	48.119	275	47.76	40.640	1.000	55014604			
08-07	JUNCTION PIT	600	900	375	47.81	375	47.76	49.648	1.888	EDCM 601			
08-08	SIDE ENTRY PIT	600	900	375	47.91	375	47.86	49.802	1.942	EDCM 601			
08-09	DOUBLE SIDE ENTRY PIT	600	900	300 300	48.01 48.126	375	48.076	49.9	1.824	EDCM 601			
06-09	DOUBLE SIDE ENTRY PIT	800	900	300	48.176	3/3	46.076	49.9	1.024	EDCIVI 601			
				300	48.176								
08-10	SIDE ENTRY PIT	600	900	300	48.317	300	48.267	50.016	1.749	EDCM 601			
08-10	SIDE ENTRY PIT	600	900	300	48.611	300		50.235	1.674	EDCM 601			
00 11	SIDE ENTRY I'II	000	300	300	48.611	300	40.501	30.233	1.074	LDCW 001			
08-12	DOUBLE SIDE ENTRY PIT	600	900	300	10.011	300	48.681	50.102	1.421	EDCM 601			
08-14	DOUBLE SIDE ENTRY PIT	600	900			300	47.282	48.866	1.585	EDCM 601			
08-15	JUNCTION PIT	600	900	375	47.151	375	47.101	48.826	1.725	EDCM 601			
08-16	DOUBLE SIDE ENTRY PIT	600	900	375	47.259	375	47.209	48.802	1.593	EDCM 601			
				300	47.284								
08-17	DOUBLE SIDE ENTRY PIT	600	900	375	47.356	375	47.306	48.79	1.484	EDCM 601			
08-19	SIDE ENTRY PIT	600	900	300	47.635	375	47.56	49.419	1.859	EDCM 601			
				300	47.76								
08-20	SIDE ENTRY PIT	600	900	300	47.797	300	47.747	49.579	1.832	EDCM 601			
08-21	SIDE ENTRY PIT	600	900	300	48.155	300	48.105	49.863	1.758	EDCM 601			
				300	48.155								
08-22	SIDE ENTRY PIT	600	900	200	10.00	300	48.65	50.11	1.461	EDCM 601			
08-23	SIDE ENTRY PIT	600	900	300	48.09	300	47.99	49.513	1.523	EDCM 601			
08-24	GRATED PIT	600	900	300	48.313	300	48.263	49.679	1.416	EDCM 601			
08-25	JUNCTION PIT JUNCTION PIT	600	900	200	48.155	300	48.416	49.772 49.715	1.355	EDCM 601 EDCM 601			
08-26 08-27	JUNCTION PIT	600 600	900	300 300	48.155	300 300	48.105 48.363	49.715	1.61 1.155	EDCM 601			
08-27	JUNCTION PIT	600	900	300	70.413	300	48.922	49.907	0.985	EDCW 601			
08-29	SIDE ENTRY PIT	600	900	300	47.928	300	47.878	49.618	1.74	EDCM 601			
08-30	SIDE ENTRY PIT	600	900		17.520	300	48.24	49.863	1.623	EDCM 601			
08-31	SIDE ENTRY PIT	600	900			300	47.374	48.959	1.585	EDCM 601			
08-32	SIDE ENTRY PIT	600	900			300	47.482	49.201	1.719	EDCM 601			
08-33	SIDE ENTRY PIT	600	900			300	47.904	49.494	1.59	EDCM 601			
08-34	JUNCTION PIT	600	900			300	48.405	50.126	1.721	EDCM 601			
08-35	SIDE ENTRY PIT	600	900			300	48.066	49.75	1.683	EDCM 601			
08-36	DOUBLE SIDE ENTRY PIT	600	900			300	48.233	49.848	1.615	EDCM 601			
08-37	DOUBLE SIDE ENTRY PIT	600	900	300	48.246	300	48.196	49.829	1.633	EDCM 601			
08-38	DOUBLE SIDE ENTRY PIT	600	900			300	48.293	49.807	1.513	EDCM 601			
08-39	SIDE ENTRY PIT	600	900			300	48.696		1.499	EDCM 601			
08-40	JUNCTION PIT	600	900			300	49.314		1.187	EDCM 601			
08-41	SIDE ENTRY PIT	600	900			300		50.376	1.742	EDCM 601			
08-42	DOUBLE SIDE ENTRY PIT	600	900			300	48.38	50.317	1.936	EDCM 601			
			1	<u>I</u>	ı	<u> </u>	1						

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AS CONSTRUCTED


SCALE AS SHOWN AT A1





Marigold - Stage 8
Wyndham City Council
Road and Drainage
Pit Schedule

MELWAYS REF PROJECT / DRAWING No. 2360E-008-351

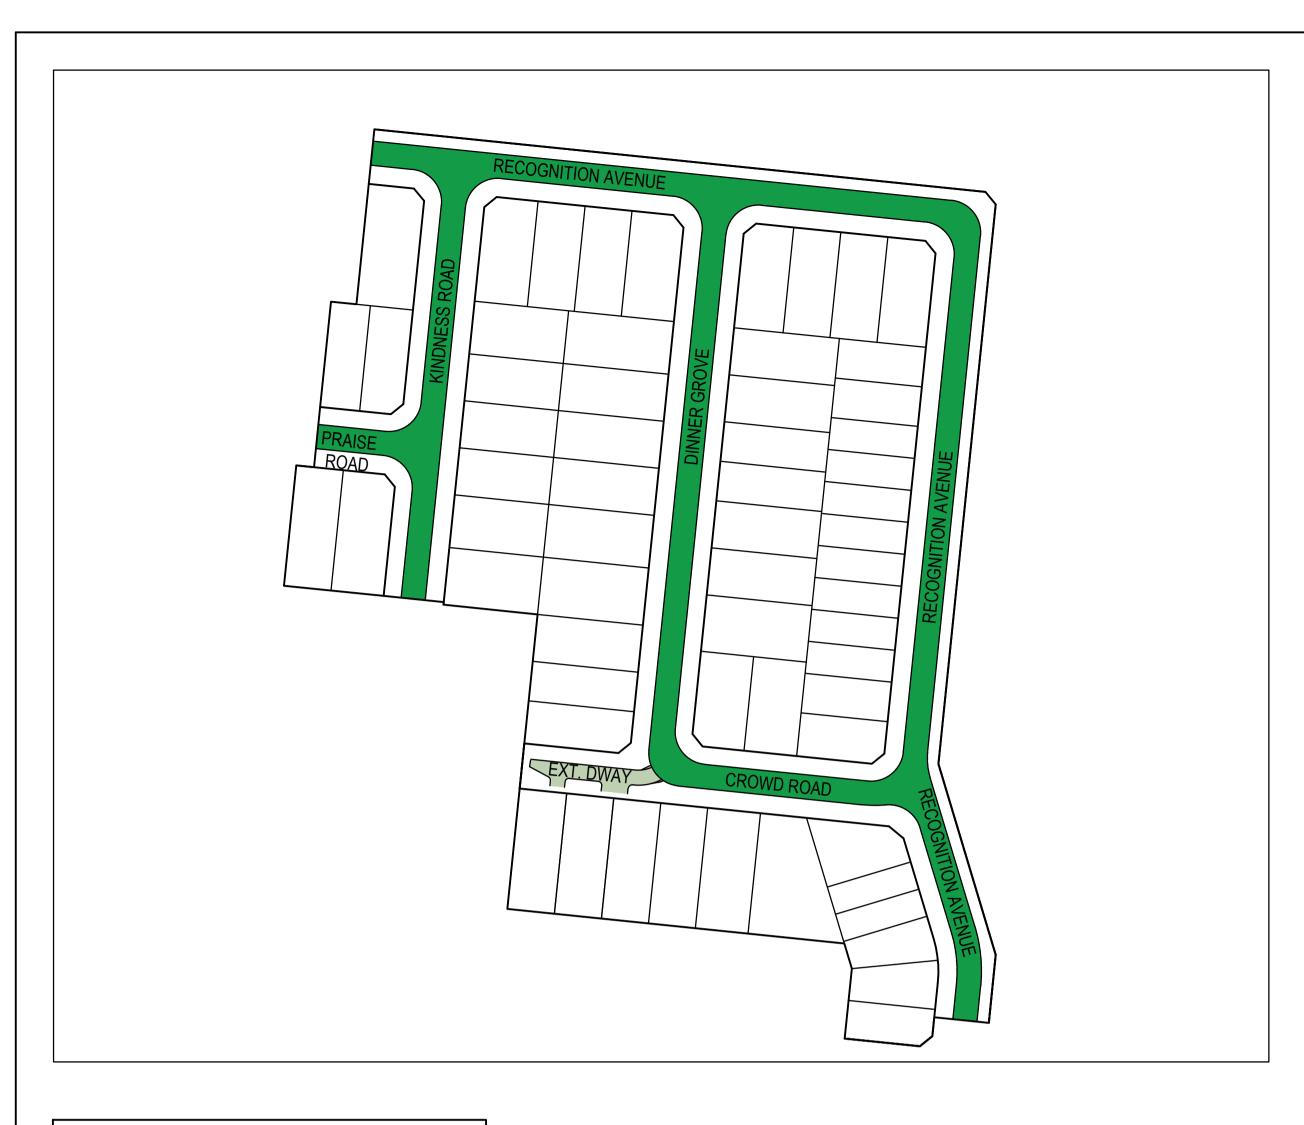

JOINT DETAIL NOTES:


- SAW JOINTS ARE TO BE PLACED AT A MAXIMUM 5m SPACING AT INTERSECTIONS AND CONSTRUCTED 18-24 HOURS AFTER POURING.
- TRANSVERSE/CONTRACTION JOINTS ARE TO BE PLACED AT A MAXIMUM SPACING OF 12m.
- EXPANSION JOINTS ARE TO BE PLACED AT A SPACING OF 12m.


PAVEMENT DESIGN FOR RESIDENTIAL STREETS 1997".

ISOLATION JOINTS ARE TO BE PLACED AROUND PITS. ALL JOINTS SHALL BE LOCATED AND SPACED IN ACCORDANCE WITH "CEMENT AND CONCRETE ASSOCIATION OF AUSTRALIA - CONCRETE


NOTES:

1. CONCRETE SHALL BE CURED IN ACCORDANCE WITH AS3600 AND NOT TO BE TRAFFICKED UNTIL AT LEAST SEVEN DAYS AFTER POURING.

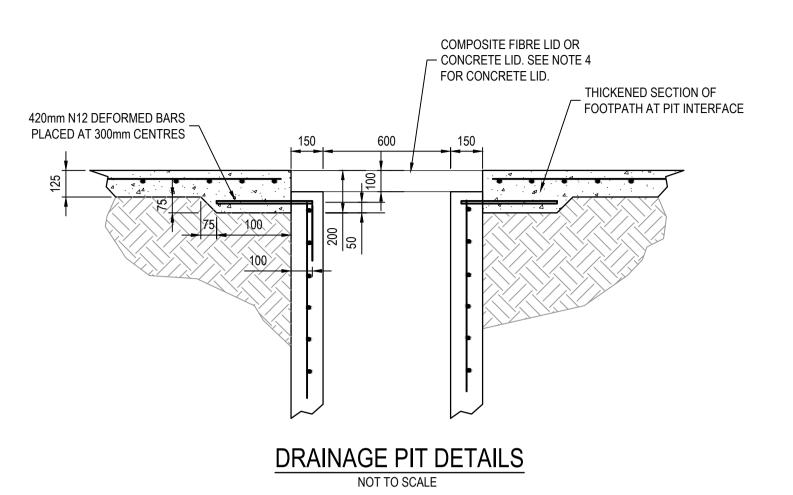

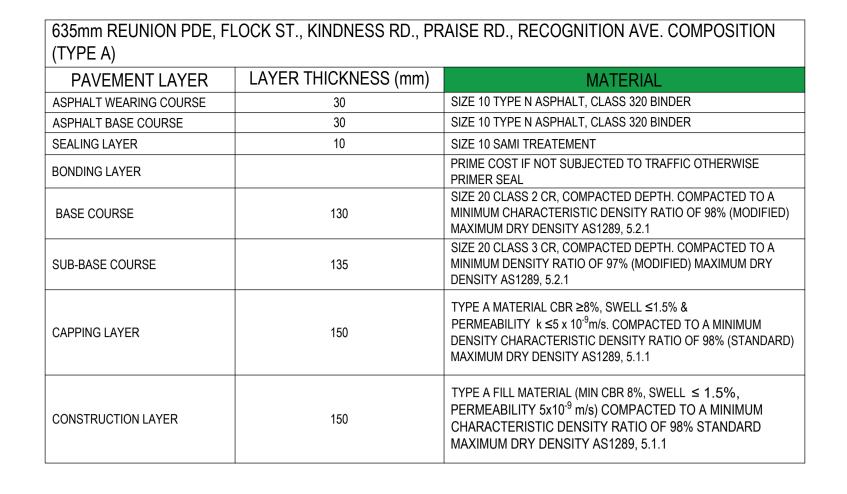

400mm EXTENDED DRIVEWAY PAVEMENT COMPOSITION										
PAVEMENT LAYER	LAYER THICKNESS (mm)	MATERIAL								
CONCRETE	200	32MPa CONCRETE WITH SL82 MESH LOCATED 50mm FROM TOP MESH TO HAVE 50mm COVER ALL EDGES								
INTERMEDIATE COURSE 1	100	SIZE 20 CLASS 3 CRUSHED ROCK								
CAPPING LAYER	150	TYPE A CAPPING LAYER CBR ≥ 8%, SWELL ≤ 1.5% & PERMEABILITY ≤ 1x10°9m/s SUBGRADE (DESIGN CBR 3%)								

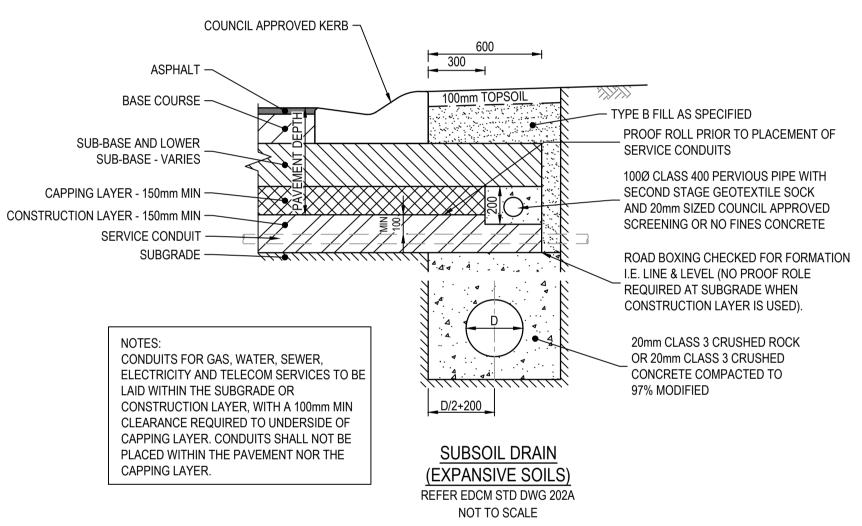

PAVEMENT NOTE

ALL PAVEMENT DESIGNS HAVE BEEN PROVIDED BY TONKIN AND TAYLOR. SMEC IS NOT RESPONSIBLE FOR GEOTECHNICAL OR PAVEMENT RELATED DESIGNS AND IS NOT RESPONSIBLE FOR THE ACCURACY, ADEQUACY OR APPROPRIATENESS OF THESE DESIGNS. THE PAVEMENT COMPOSITIONS SHOWN ON THIS DRAWING HAVE BEEN REPRODUCED FROM THE PAVEMENT REPORT (1008776.1000v3) FOR THIS DEVELOPMENT STAGE. THIS DOCUMENT SHOULD BE REVIEWED BY THE CONTRACTOR TO ENSURE DESIGN HAS BEEN INTERPRETED CORRECTLY. A COPY OF THIS DOCUMENT WILL BE MADE AVAILABLE ON REQUEST.

THE PAVEMENT SHOULD COMPRISE ROAD BASE OR SUBBASE QUALITY MATERIALS SPREAD IN LAYERS NOT EXCEEDING 200mm LOOSE LAYER THICKNESS, MOISTURE CONDITIONED TO WITHIN ± 2% MODIFIED OPTIMUM MOISTURE CONTENT (OMC) AND COMPACTED TO A DRY DENSITY RATIO OF 98% MODIFIED, PLACES IN ACCORDANCE WITH VICROADS REQUIREMENT.

WARNING BEWARE OF UNDERGROUND SERVICES

The locations of underground services are approximate only and their exact position should be proven on site. No guarantee is given that all existing services are shown. ocate all underground services before commencement of works DIAL 1100 BEFORE YOU DIG www.1100.com.au

AS CONSTRUCTED PLANS

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AS CONSTRUCTED



SCALE AS SHOWN AT A1




(C) ABN 47 065 475 149 Collins Square, Tower 4, Level 20, 727 Collins St Melbourne, VIC 3008 Ph 03 9514 1500



Marigold - Stage 8
Wyndham City Council
Road and Drainage Pavement Details

PROJECT / DRAWING No.


REVISION 2360E-008-411

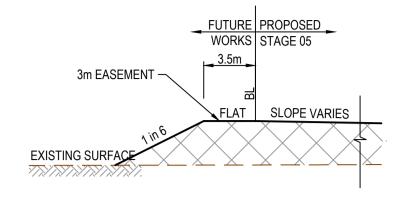



FILL BATTER (OVER EASEMENT)

INTO FUTURE LOT

NOT TO SCALE

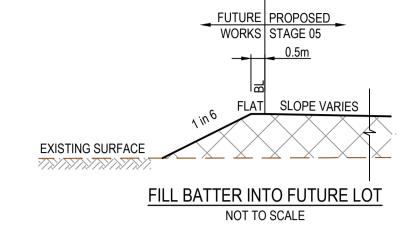


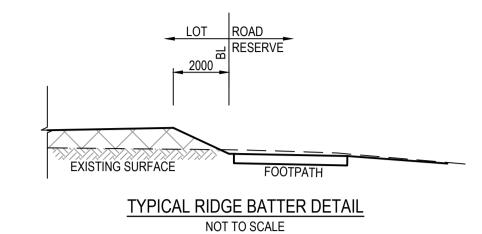


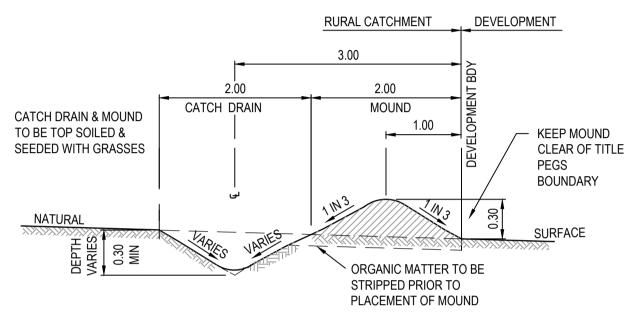



TYPICAL SECTION THROUGH CUT OFF DRAIN

NOT TO SCALE

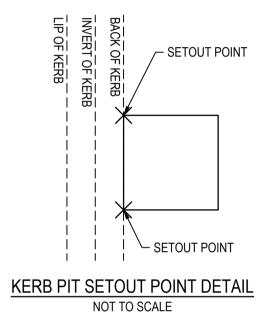

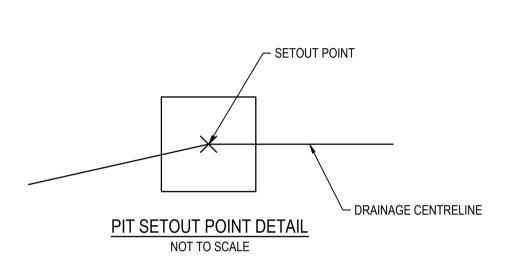

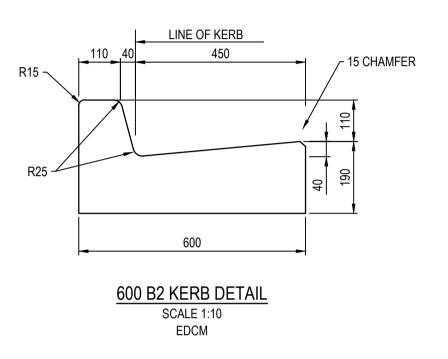

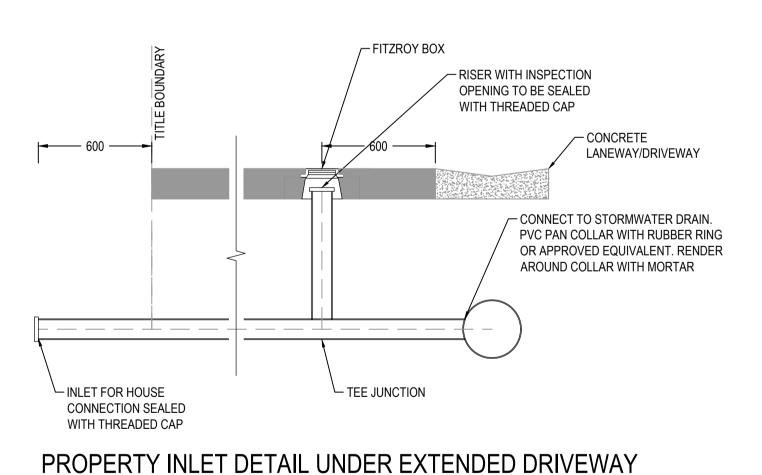

NOT TO SCALE


AS CONSTRUCTED PLANS

The purpose of these as-constructed plans is to update the design drawings to show significant changes which occurred during construction. Note that the levels shown on these plans are design levels, and have not been verified by survey. All information shown on these plans should be verified on site. SMEC Australia Pty Ltd accept no responsibility for loss or damages resulting from the inappropriate usage of these plans.








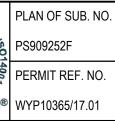

AS CONSTRUCTED

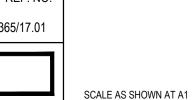





Marigold - Stage 8 Wyndham City Council Road and Drainage General Details

 GROWLAND
 MELWAYS REF 359 F9
 PROJECT / DRAWING No. 2360E-008-421
 SHEET No. 18 o

<u>PHASE</u>		SCIPLINE CODE	POTENTIAL RISK (Construction, Operations, Maintenance)		RISK OWNER	POTENTIAL CONSEQUENCES	POTENTIAL ELIMINATION MEASURE, DESIGN INITIATIVE or CONTROL (Identify any Standard or Code of practice used)	HOW ISSUE ADDRESED IN DESIGN AND/OR CONSTRUCTION OF THE WORKS	IS THE RISK ELIMINATED? YES / NO	RESIDUAL RISK LIKELIHOOD (0-5)	RESIDUAL RISK CONSEQUENCE (0-5)		RESIDUAL RISK OWNER
Road Furniture /	Roadside	Features											
Construction	RD	Roads	Construction close to live traffic	New works will be constructed adjacent to live traffic when abutting existing stages.	Contractor	Disruptions to live traffic, construction incident involving live traffic.	Provide safe temporary traffic control (TCP)	TCP provided within contract	N	5	3	15	Constructor
Construction	US	Utilities or Services	Utilities become a hazard within clear zones	Vehicle conflict with utility / pit	Contractor	Personal injury, vehicle damage	Sequence works and protect with temp barrier or traffic control (TCP)	TCP provided within contract	N	1	5	5	Constructor
Operational	RD	Roads	Sight Lines	Inadequate drivers response time.	Road Authority	Increased potential for accidents	Ensure design complies with relevant standard. Undertake thorough Safety Audit	Vis lines checked and discussed with approval authority as part of design approval process	N	1	4	4	Road Authority
Operational	LS	Lines and Signs	Signs and street lights	Potential for drivers / riders to strike signs and street lights	Road Authority	Increased potential for accidents	Ensure design complies with relevant standard. Undertake thorough Safety Audit	Refer to appropriate standard for sign and lighting offsets	N	1	4	4	Road Authority
Operational	RF	Road Furniture	Headwalls	Potential vehicle conflict within clear zone	Road Authority	Increased potential for accidents	Establish adequate clear zone provision	Adequate barrier provided as per appropriate standard where within clear zone. Culvert headwall selection in accordance with authority standard	N	2	4	8	Road Authority
Operational	RD	Roads	Culverts	Potential fall hazard during maintenance, by vechicles and pedestrians	Relevant Authority	Falling from a height	Barriers to be provided in accordance with road standards	Barriers to be provided and safe batter slopes (>1:3)	N	2	5	10	Constructor
Drainage													
Operational	DR	Drainage	Grated Pits	Trip/fall hazard with large spaced grate	Relevant Authority	Increased potential for accidents	Provide pedestrian/bicycle friendly grates where applicable. Refer to pit schedule	Design in accordance with authority and manufacturers standards	N	3	2	6	Authority
Operational	DR	Drainage	Non Standard Large Pits	Potential for pit failure	Relevant Authority	Increased risk to maintenance crews/ vehicles	Structural design in accordance with relevant design principles.	Refer to structural drawings and calculations	N	1	4	4	Authority
Maintenance	DR	Drainage	Access to Pits	Lack of safe access for maintenance	Relevant Authority	Increased risk to maintenance crews	Provide safe working conditions for maintenance. Provide safe landing/ access arrangements as per relevant authority standards	Where possible design pit in location for easy access and outside of permanent water bodies	N	2	5	10	Authority
Maintenance	DR	Drainage	Deep Pits	Lack of safe entry for maintenance	Relevant Authority	Increased potential for accidents	Contractor to be certified for work in confined spaces, step irons to be provided to appropriate authority standards. Refer to pit schedule	Design in accordance with authority standards	N	1	5	5	Authority
Maintenance	DR	Drainage	Access to drains / culverts	Lack of safe access for maintenance	Relevant Authority	Increased risk to maintenance crews	Provide safe working conditions for maintenance. Access as approved by authority	Design pit in location for easy access as agreed with authority	N	2	3	6	
Sewer	•												
Maintenance	SE	Sewer	Deep Manholes	Lack of safe entry for maintenance	Relevant Authority	Increased potential for accidents	Contractor to be certified for work in confined spaces, landings and step access provided as per authority standards and schedule	Design in accordance with authority standards. Refer pit schedule on drawings	N	1	5	5	Authority
Maintenance	SE	Sewer	Access to Manholes	Lack of safe access for maintenance	Relevant Authority	Increased risk to maintenance crews	Provide safe working conditions for maintenance. Manholes located in compliance with authority standards	Where possible design manhole in location for easy access	N	1	5	5	Authority
Electricity	•												
Operational	ES	Electrical Services	Electrical Design	Location of assets within clear zones e.g., pits/ substations	Relevant Authority	Increased potential for accidents	Electrical designed by sub consultant with appropriate accreditation and in accordance with authority standards	Pits designed below ground. Where above ground adequate offset from vehicle clear zones has been provided or barrier protection provided	N	2	3	6	Authority
Telstra													
Operational	TE	Telstra	Telstra Design	Location of assets within clear zones e.g., pits	Relevant Authority	Increased potential for accidents	Telecommunications designed by authority consultant with appropriate accreditation and in accordance with authority standards	Pits designed below ground. Where above ground adequate offset from vehicle clear zones has been provided or barrier protection provided	N	2	3	6	Authority
Water													
Operational	WA	Water	Water Design	Location of assets within clear zones e.g., pits/ substations	Relevant Authority	Increased potential for accidents	Water pits designed in accordance with authority standards	Pits designed below ground. Where above ground adequate offset from vehicle clear zones has been provided or barrier protection provided	N	2	3	6	Authority
Gas													
Operational	GA	Gas	Gas Design	Location of assets within clear zones e.g., pits/ substations	Relevant Authority	Increased potential for accidents	Water pits designed in accordance with authority standards	Pits designed below ground. Where above ground adequate offset from vehicle clear zones has been provided or barrier protection provided	N	1	1	1	Authority

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AS CONSTRUCTED



PLAN OF SUB. NO.

SCALE AS SHOWN AT A1





Marigold - Stage 8 Wyndham City Council Road and Drainage Safety In Design

MELWAYS REF PROJECT / DRAWING No. 2360E-008-500